



WTA ARCHITECTS

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WTAARCH.COM

## BULLETIN NO. 1

### 491/20167.SDW - PHASE 500: CENTER FOR FORENSIC PSYCHIATRY- CREATE KITCHEN SALINE, MICHIGAN

WTA Project No. 2021094  
January 08, 2025

The Contractor will kindly forward to the office of the Architect, within seven days of receiving this bulletin, the change in their contract amount for the following work items listed below. Please submit a quotation for each item listing itemized material costs and itemized labor costs, including the number of hours to complete the work.

#### ARCHITECTURAL

Item A1      Reference Sheets A2.01 (**Re-Issued**)  
A. Added smoke area #13 with new smoke barrier between kitchen and corridors.

Item A2      Reference Sheets A2.01, A2.02, & A3.01 (**Re-Issued**)  
A. Revised rated walls in Stair (H121), Stair (H200.A), (Kitchen (H123), Dry Storage (H124), and Storage (H119).  
B. Revised fire ratings for doors H121.A, H122.A, H122.B, H122.C, H124.A, H132.B, & H200.A.  
C. Added smoke area #13 and revised smoke area #12.

Item A3      Reference Sheets A2.01, A2.02, A2.21, & A9.01 (**Re-Issued**)  
A. Revised door H132.A to be double-egress doors (refer to Structural).

Item A4      Reference Sheets A2.21 (**Re-Issued**)  
A. Added notes to provide CMU infill above new door.  
B. Field Condition Clarifications: Revise location of west wall of Corridor Connector (H132) to be flush with edge of existing window as indicated on re-issued sheet.  
C. Field Condition Clarifications: Revise location of door H120.A as indicated on re-issued sheet.

#### STRUCTURAL

Item S1      Reference Sheets S2.01, S2.02, S5.01, & S7.01 (**Re-Issued**)  
A. Add deck edge angles and detail for corridor ends.  
B. Clarification: remove erroneous mechanical lintel callouts.  
C. Reduction of steel members at Line @C following shop drawing review.  
D. Stair framing changes following shop drawing review.  
E. Addition of tube steel member at stair tower for brick support.  
F. Additional bracing angles at top of column @2-@C.  
G. Steel support frames for existing AC unit relocation to ex building roof.

WIGEN  
TINCKNELL  
ASSOCIATES  
ARCHITECTS

SPACE SOLVED.

CENTER FOR FORENSIC PSYCHIATRY- CREATE KITCHEN  
BULLETIN NO. 1  
JANUARY 08, 2025  
PAGE 2



MECHANICAL

Item M1      Reference Sheet M3.01 (**Not Re-Issued**)  
A. RFI #10 changed the RCP length. "Provide 9'-8" RCP's with 2' of spacing as recommended."

Item M2      Reference Sheet M7.03 (**Re-Issued**)  
B. Increase pump HP for P-54 and P-55.

Item M3      Reference Sheet M8.04 (**Not Re-Issued**)  
C. Line #1 from HWH sequence of operation needs to be removed.  
Boiler is always active due to VAV box reheat.

ELECTRICAL

Item E1      Reference Sheet E5.01 (**Re-issued**)  
A. Increase pump HP and FLA for P-54 and P-55.


END OF BULLETIN NO. 1

**WTA** ARCHITECTS

Cariann Davitt Schartow

Attachments: Sheets A2.01, A2.02, A2.21, A3.01, A9.01, S2.01, S2.02, S5.01, S7.01, M7.03, & E5.01

Cc:    Antler Construction Company, Inc.  
          Department of Technology, Management and Budget  
          Peter Basso Assoc., Inc.  
          MacMillian Assoc., Inc.  
          WTA Architects  
          CommTech Design  
          Stafford Smith  
          ROWE Professional Services Company

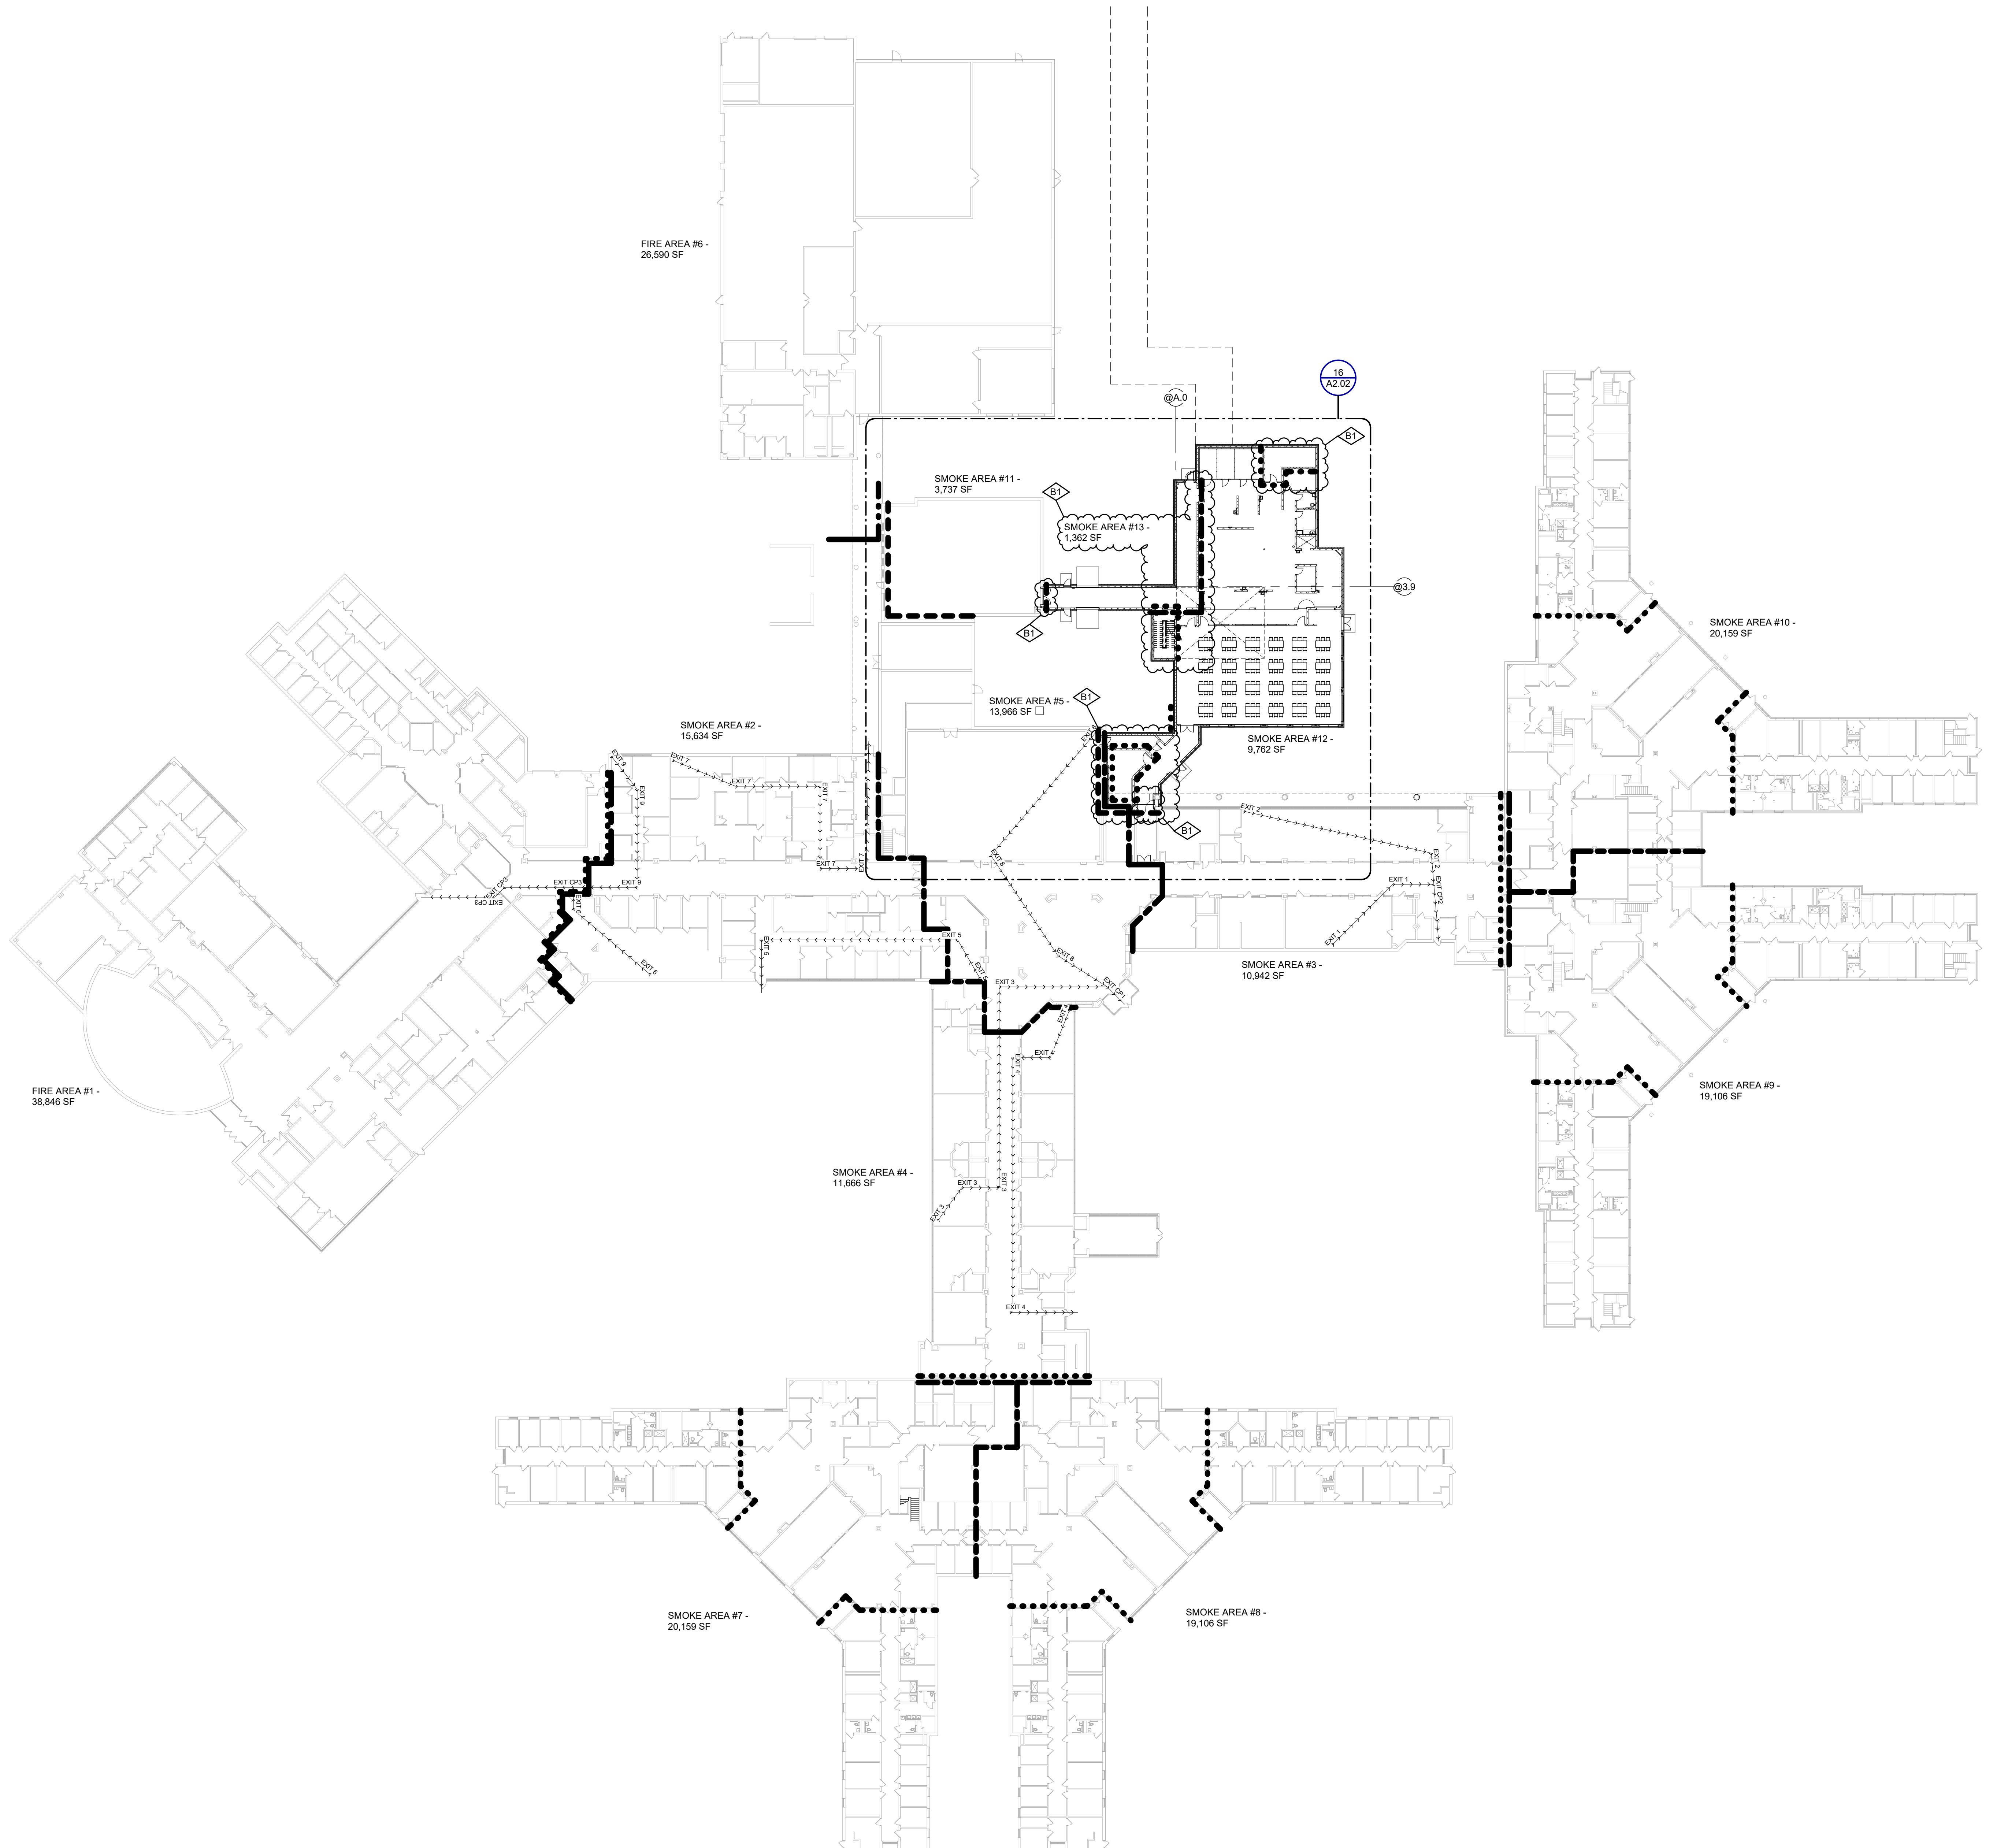


CODE LEGEND	
● ● —	3-HOUR BUILDING SEPARATION
— — —	2-HOUR BARRIER
● ● ● —	1-HOUR ENCLOSURE / FIRE RESISTANCE RATING
— — —	1-HOUR SMOKE BARRIER
→ → →	TRAVEL DISTANCE
□	100% SPRINKLED
DF	DRINKING FOUNTAIN
FE	FIRE EXTINGUISHER
724	OCCUPANT LOAD
#	EXIT CAPACITY
CODE PLAN EGRESS PATH LENGTH	
ID	LENGTH
CP1	11'
CP2	26'
CP3	71'
1	58'
2	102'
3	177'
4	187'
5	134'
6	56'
7	186'
8	156'
9	93'

CODE PLAN EGRESS PATH LENGTH		
ID	DESCRIPTION	LENGTH
CP1		11'
CP2		26'
CP3		71'
1		58'
2		102'
3		177'
4		187'
5		134'
6		56'
7		186'
8		156'
9		93'

STATE OF MICHIGAN  
DEPARTMENT OF TECHNOLOGY, MANAGEMENT AND BUDGET  
FACILITIES AND BUSINESS SERVICES ADMINISTRATION  
DESIGN AND CONSTRUCTION DIVISION

NO. 00107-00144

ING CODE CONTRACT NO.  
QDHHS7255 Y22003

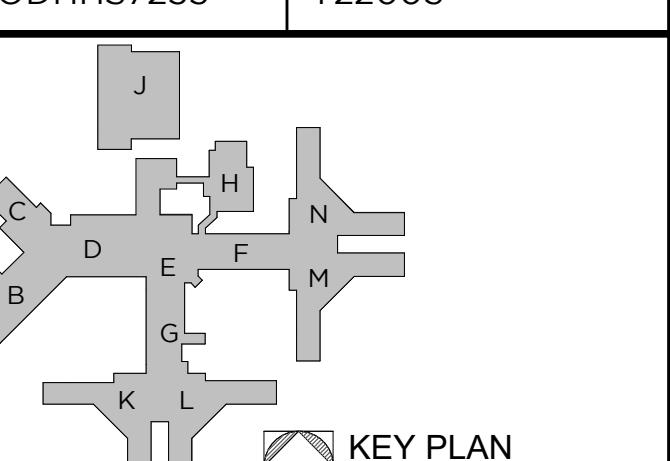

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Raw, Michigan 48607

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# PROJECT TITLE 1/20167.SDW - PHASE 500: ENTER FOR FORENSIC PSYCHIATRY - CREATE


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IT TITLE

IRST FLOOR MASTER  
ODE AND TEMPORARY  
RESS PLAN


PROJECT NUMBER 021094	SHEET NUMBER A2.01
PROJECT DATE SEPTEMBER 6, 2023	
MADE BY D.S.	




FIRST FL  
SCALE: 1/32"
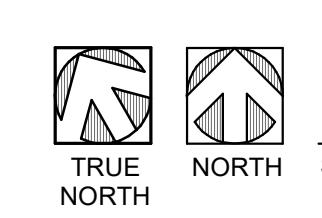
# DOOR CODE MASTER PLAN

CENTER FOR FORENSIC PSYCHIATRY - BUILDING CODE NOTES				
CODE REFERENCE	2012 NFPA 2015 MICHIGAN BUILDING CODE ANSI A117.1 2015 PLUMBING CODE 2015 ELECTRICAL CODE 2015 MECHANICAL CODE			
DESCRIPTION	REFERENCE	EXISTING	NEW ADDITION	REMARKS
OCCUPANCY CLASSIFICATION	MBC 303.3 / 308.4	I-2 CONDITION 1	A-2	ASSEMBLY - DINING FACILITY & ASSOCIATED KITCHEN / INSTITUTIONAL - PSYCHIATRIC HOSPITAL
CONSTRUCTION TYPE	MBC 601	IB	IIB	TYPE IIB: RATING FOR BLDG ELEMENTS = 0-HOUR TYPE IB: RATING FOR BLDG ELEMENTS = 2-HOUR EXCEPTION: NONBEAR INT WALLS = 0-HOUR ROOF = 1-HOUR
NONBEARING EXTERIOR WALL SEPARATION	MBC 602	IIB > 30 FT = 0-HOUR	IIB-A = 0-HOUR	
FEATURES OF FIRE PROTECTION		FULLY SPRINKLED		
BUILDING HEIGHT	MBC 504.4	ALLOWED - 5 STORIES 180 FT.	ALLOWED - 3 STORIES 75 FT.	A-2: ACTUAL - 1 STORY - 18 FT.
BUILDING AREA	MBC 506.2	UNLIMITED	ALLOWED - 38,000 S.F.	A-2: ACTUAL - 11,124 S.F.
SEPARATED OCCUPANCIES	MBC 508.4	I-2	A-2	2-HOUR FIRE BARRIER SEPARATION TO COMPLY WITH A-2 REQUIREMENTS
INCIDENTAL USE AREAS	MBC 509	FURNACE ROOM WITH >40,000 BTU PER HOUR INPUT = 1 HOUR OR SPR. BOILER ROOMS >15 PSI OR 10 HORSEPOWER = 1 HOUR OR SPR.		BUILDING FULLY SPRINKLERED
FIRE BARRIERS	MBC 707	SEPARATED OCCUPANCIES		CONTINUITY: TOP OF FND OR FLR/CLG ASSEMBLY TO UNDERSIDE OF FLR OR ROOF ABOVE - CONT THRU OUT CONCEALED SPACES
INTERIOR WALL/CEILING FINISHES	MBC TABLE 803.11	INTERIOR EXIT STAIRWAYS - B CORRIDORS - B ROOMS AND ENCLOSED SPACES - B ADMIN - C ≤ 4 OCC - C	ROOMS AND ENCLOSED SPACES - C	
OCCUPANT LOAD	MBC 1004.12	STOR/MECH 1,300 S.F. (GROSS) WAREHOUSE 1/500 S.F. (GROSS) INPUT 1,240 S.F. (GROSS) SLEEPING 1/20 S.F. (GROSS) DINING ROOM/SERVING 15 S.F. (NET)	KITCHEN 1,200 S.F. (GROSS) DINING ROOM/SERVING	A-2 : TOTAL OCCUPANTS = 718
FIRE EXTINGUISHERS	NFPA 10	75' MAXIMUM DISTANCE APART		
COMMON PATH EGRESS TRAVEL	MBC 1006.2.1	75'		THAT PORTION OF THE EXIT ACCESS TRAVEL DISTANCE MEASURED FROM THE MOST REMOTE POINT OF EGRESS TO THAT POINT WHERE THE OCCUPANTS HAVE SEPARATE AND DISTINCT ACCESS TO TWO EXITS OR EXIT ACCESS DOOR-WAYS.
NUMBER OF EXITS	MBC 1006.3.1		REQUIRED: (1) KITCHEN (2) DINING	PROVIDED: (2) DINING ROOM (2) KITCHEN
EXIT ACCESS TRAVEL DISTANCE	MBC 1017.2	200 FT.	250 FT.	
CORRIDOR FIRE RESISTANCE	MBC 1020.1	w/ SPRINKLER = 0 HOUR	FULLY SPRINKLERED	
MINIMUM CORRIDOR WIDTH	MBC 1020.2	MIN. 44 INCHES MIN. 96 INCHES FOR BED CLEARANCE		
DEAD END CORRIDORS	MBC 1020.4	20 FT.		
ACCESSIBILITY	MBC 1101.2		DESIGNED AND CONSTRUCTED TO BE ACCESSIBLE	
PLUMBING FIXTURES	MPC TABLE 403.1		NO ADDITIONAL STAFF OR PATIENTS ARE BEING ADDED TO THE FACILITY	
ENERGY EFFICIENCY	MEC		SO OF - INSULATION ENTIRELY ABOVE DECK = R-30 C WALLS - MASS = R-11.4 C SLAB ON GRADE = R-15 FOR 24IN.	

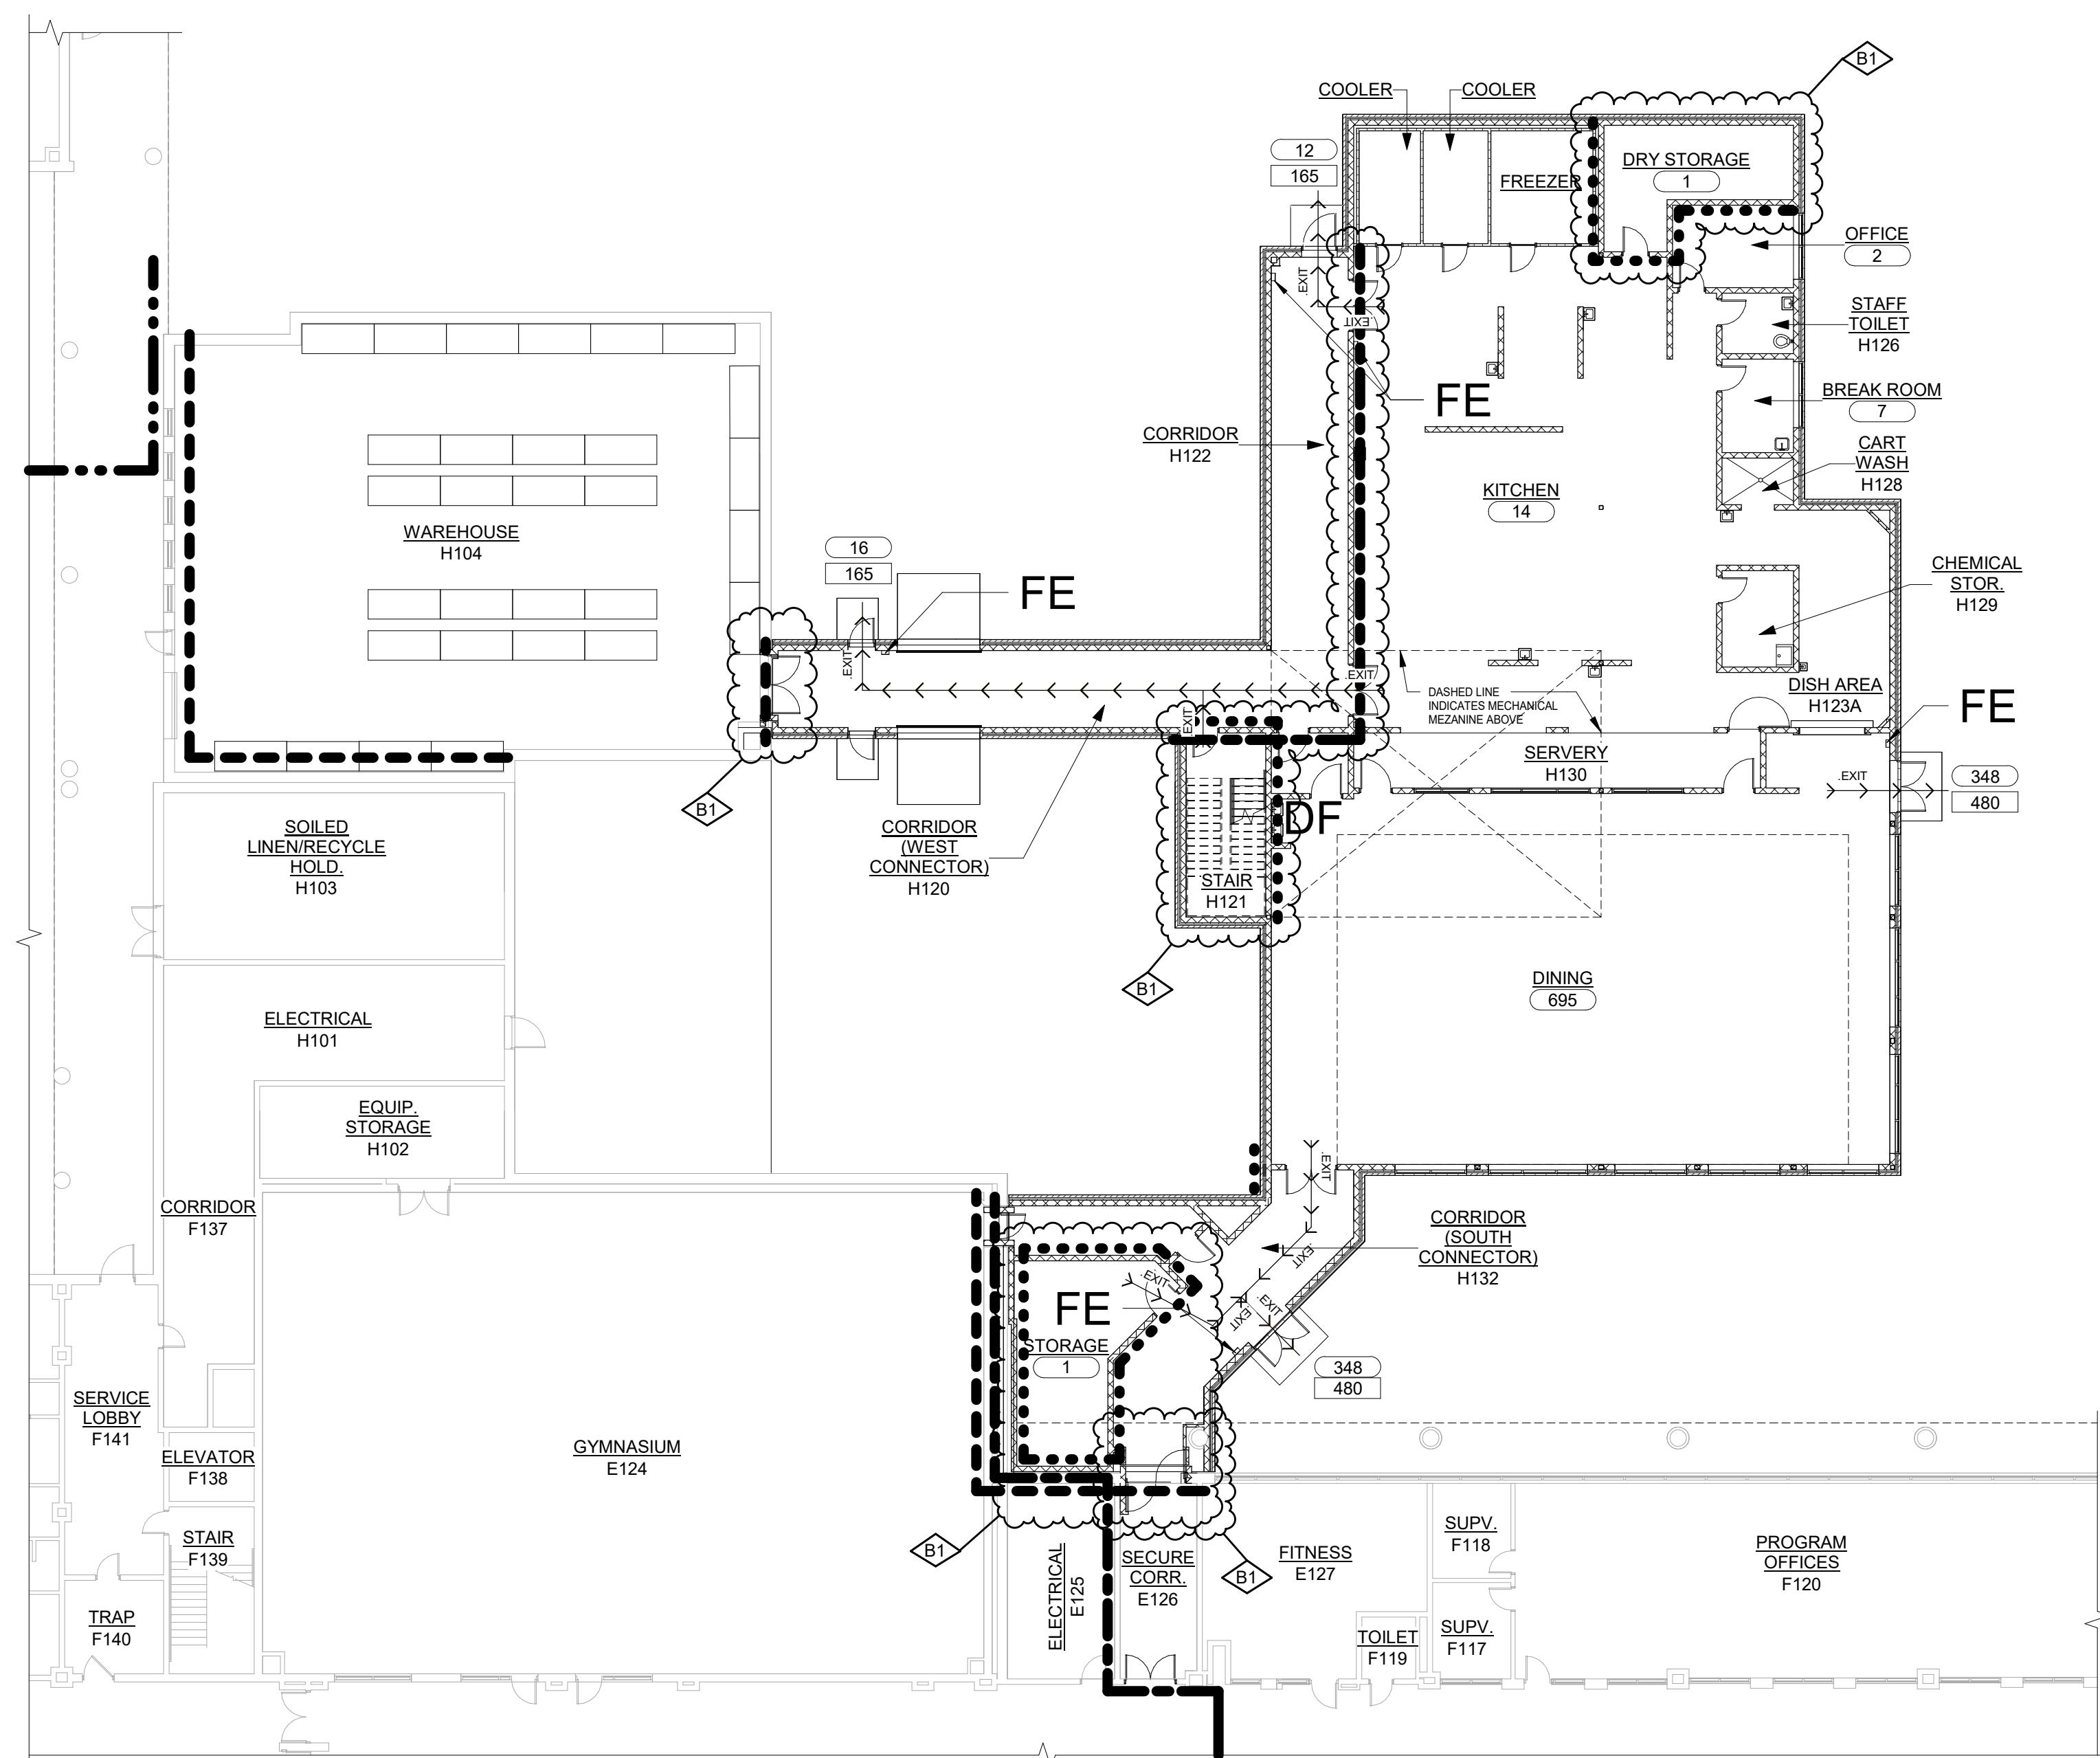

FIRST FLOOR CODE PLAN  
SCALE: 1/16" = 1'-0"

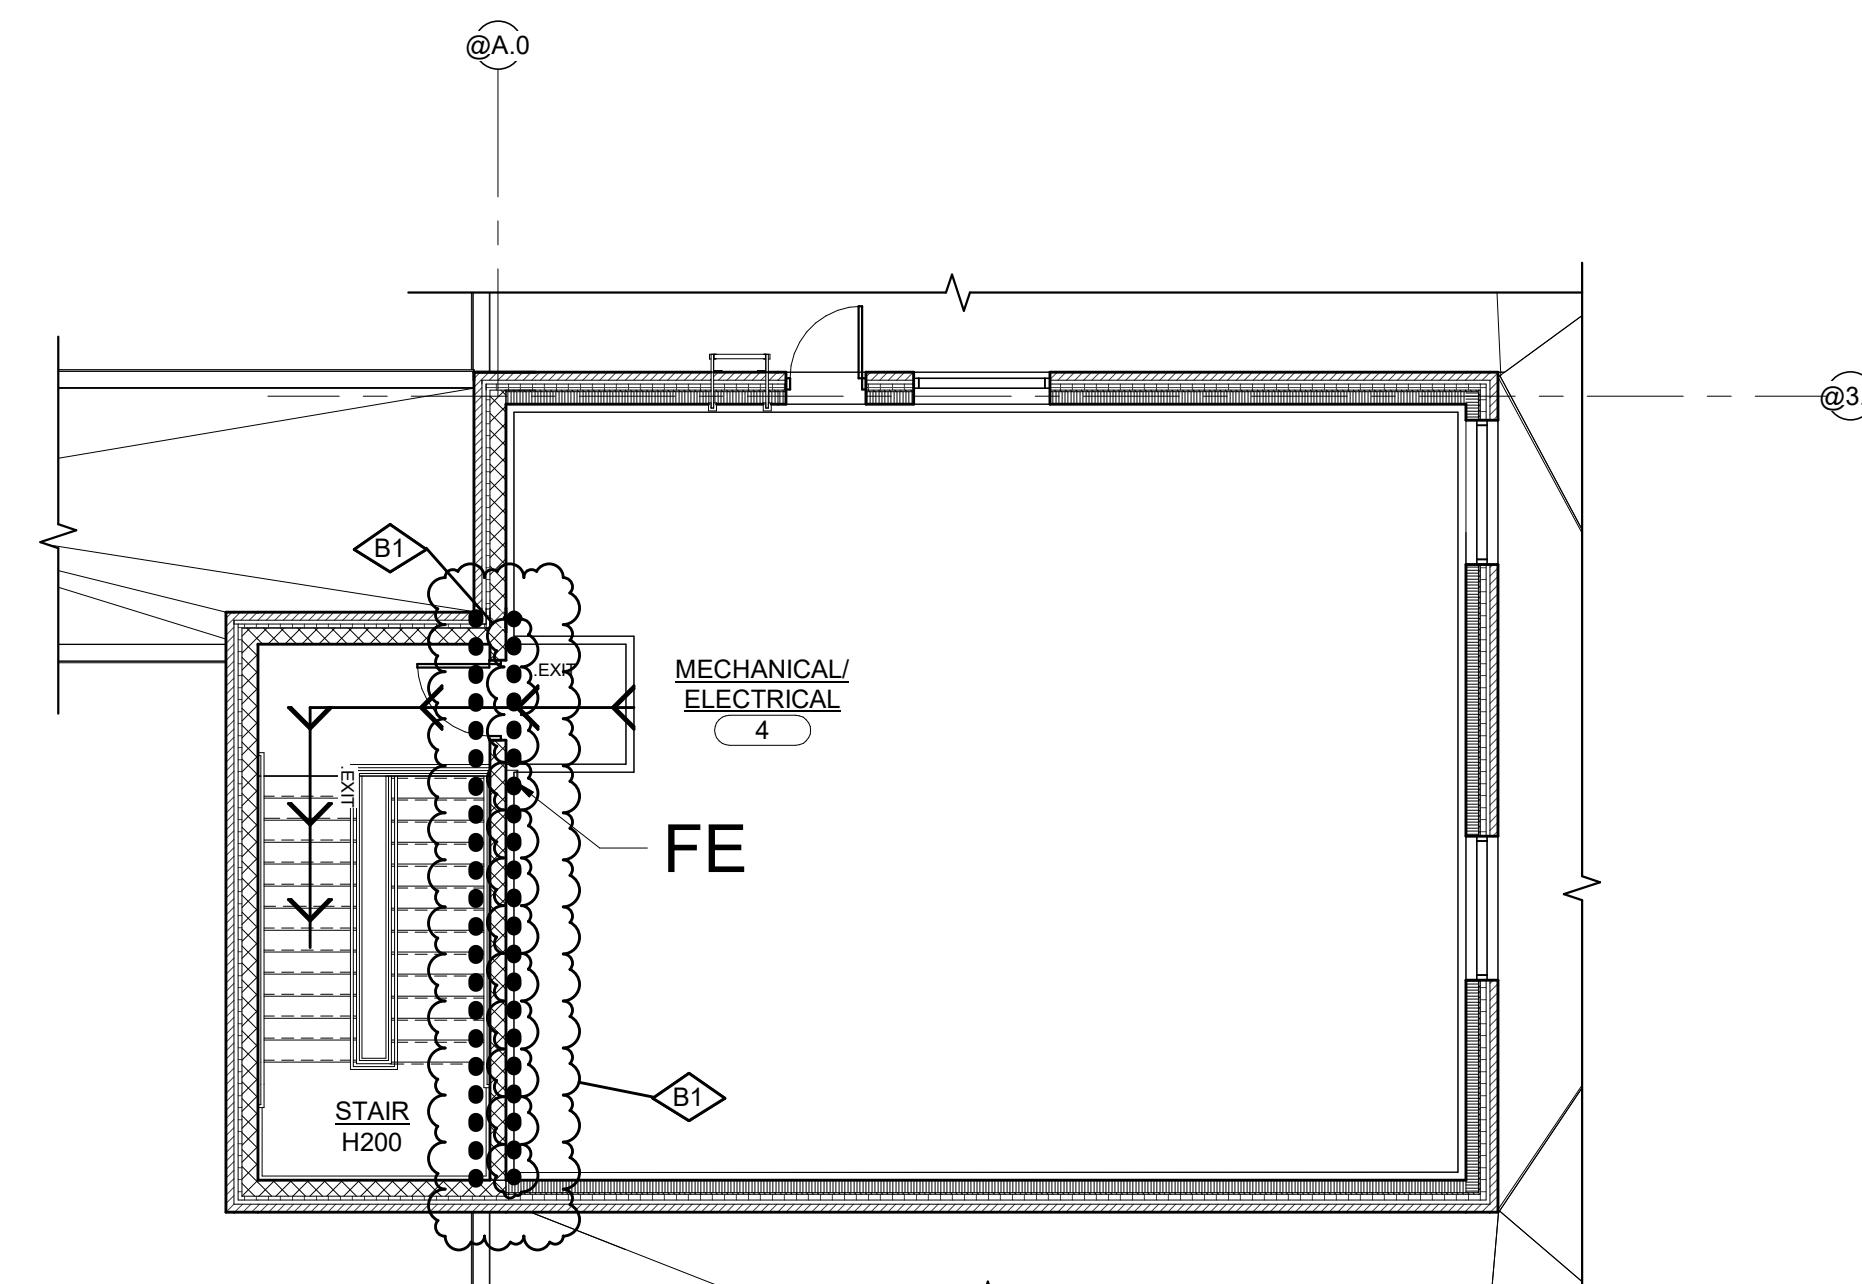

SECOND FLOOR CODE PLAN  
SCALE: 1/8" = 1'-0"

CODE LEGEND	
3-HOUR BUILDING SEPARATION	
2-HOUR BARRIER	
1-HOUR ENCLOSURE / FIRE RESISTANCE RATING	
1-HOUR SMOKE BARRIER	
TRAVEL DISTANCE	
100% SPRINKLED	
DRINKING FOUNTAIN	
FIRE EXTINGUISHER	
OCCUPANT LOAD	
EXIT CAPACITY	
DF	
FE	
724	
#	

B1 BULLETIN NO 1 01/08/25  
NO. REVISION DATE

STATE OF MICHIGAN  
DEPARTMENT OF TECHNOLOGY, MANAGEMENT AND BUDGET  
FACILITIES AND BUSINESS SERVICES ADMINISTRATION  
DESIGN AND CONSTRUCTION DIVISION  
ADAM LACH, RA, DIRECTOR

FILE NO. 491/20167.SDW  
FUNDING CODE 17ICODHHS7255 CONTRACT NO. Y22003


KEY PLAN NOT TO SCALE  
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PROJECT TITLE 491/20167.SDW - PHASE 500:  
CENTER FOR FORENSIC PSYCHIATRY - CREATE KITCHEN  
SALINE, MICHIGAN

SHEET TITLE FIRST FLOOR PARTIAL CODE PLAN

PROJECT NUMBER 2021094 SHEET NUMBER A2.02  
PROJECT DATE SEPTEMBER 6, 2023  
CHECKED BY C.D.S.



**CONSTRUCTION GENERAL NOTES:**
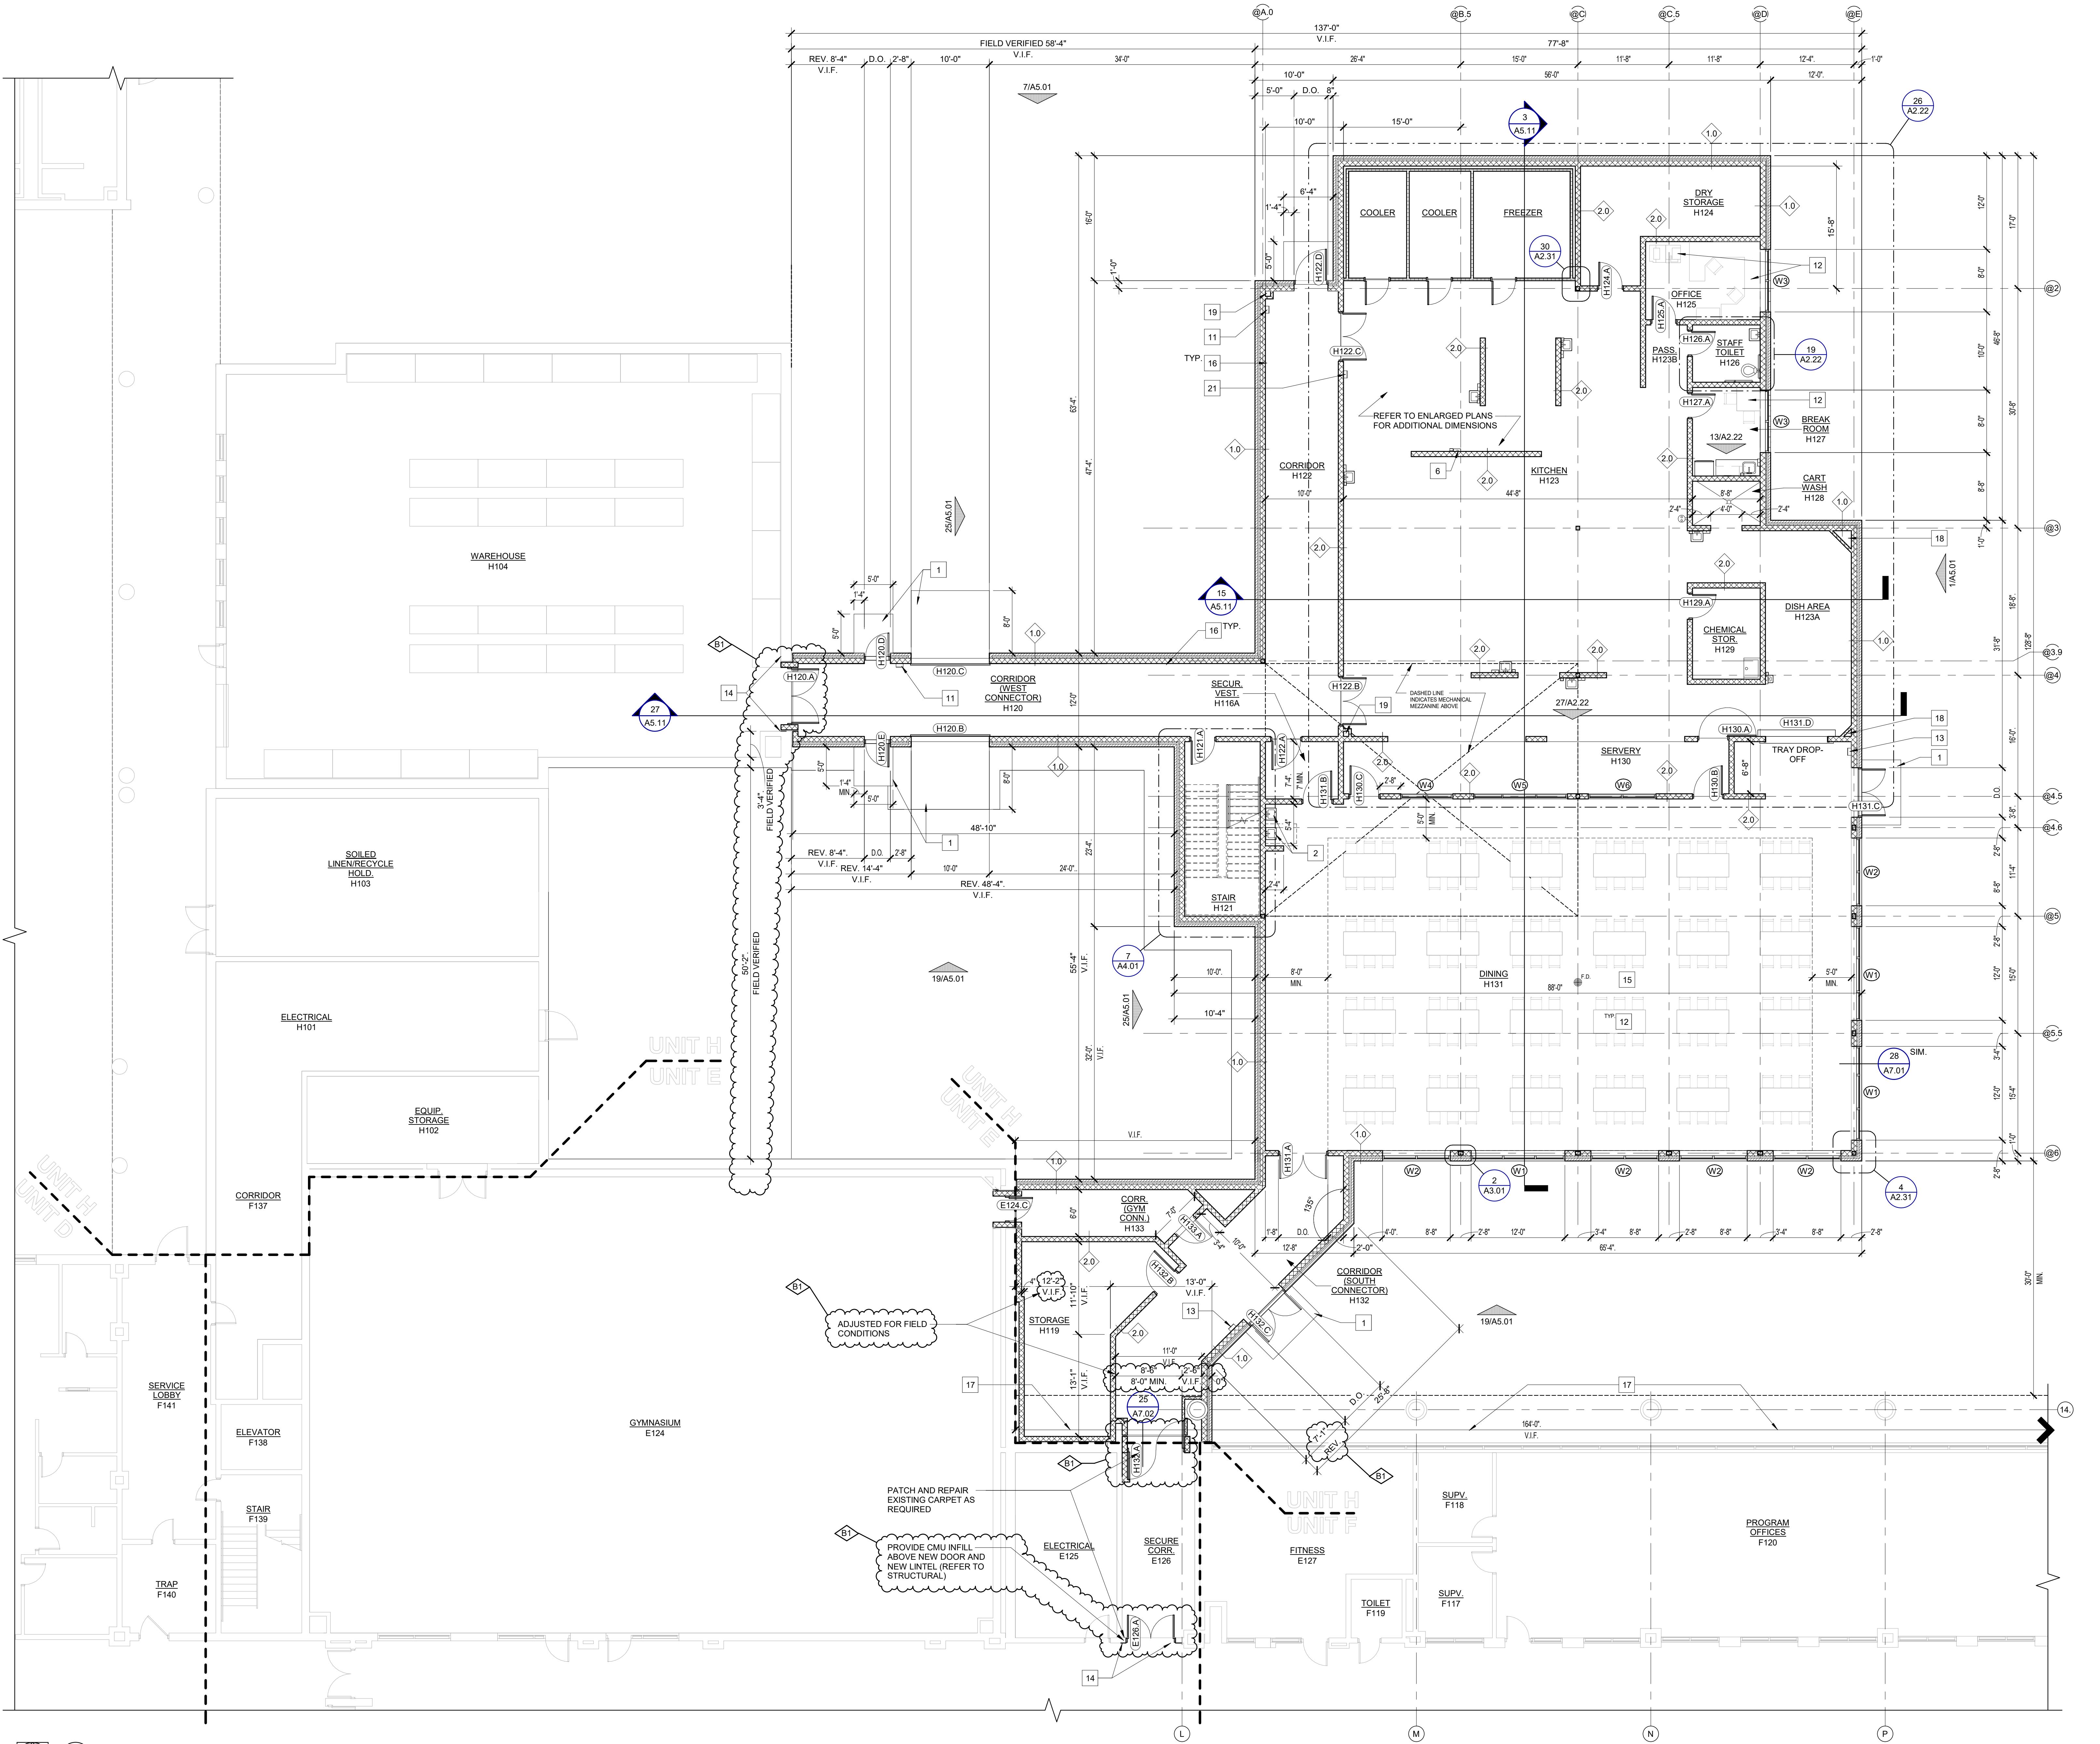
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WALL TYPES ARE INDICATED AS A DIAMOND WITH A NUMBER. REFER TO SHEET A0.01 FOR DESCRIPTION OF WALL TYPES.

PLAN DIMENSIONS DO NOT INCLUDE WALL THICKNESS (REFER TO WALL TYPES).

DOOR FRAMES ARE TO BE LOCATED 8" FROM THE PERPENDICULAR WALL ON THE HINGE SIDE OF THE DOOR AT MASONRY WALLS, UNLESS NOTED OTHERWISE.

PROVIDE BLOCKING AT ALL WALL MOUNTED ITEMS INCLUDING BUT NOT LIMITED TO: PLUMBING ACCESSORIES, KITCHEN EQUIPMENT, ETC.

ALL AREAS DAMAGED BY DEMOLITION WORK ARE TO BE PATCHED AND REPAIRED OR REPLACED TO MATCH ADJACENT SURFACES.

PATCH AND REPAIR REMAINING WALLS; AT ARCHITECTURAL, MECHANICAL, AND ELECTRICAL DEMOLITION POINTS WITH SIMILAR MATERIALS IN SIZE, COLOR AND TEXTURE.

PATCH AND REPAIR ALL EXISTING FLOORS AS REQUIRED WHERE EXISTING WALLS HAVE BEEN REMOVED.

FURNITURE OR EQUIPMENT TO BE BUILT AND/ORG INSTALLED BY CONTRACTOR IS SPECIFICALLY NOTED, DIMENSIONED OR DETAILED. ALL OTHER FURNITURE OR EQUIPMENT WILL BE PROVIDED AND INSTALLED BY OWNER.

FOR CASEWORK DETAILS - REFER TO "NORTHERN AMERICA ARCHITECTURAL WOODWORK STANDARDS (A.W.S.).

CASEWORK DESIGNATION REFERS TO THE WIDTH (W) AND DEPTH (D) OF THE CABINET. REFER TO DIMENSIONS FOR HEIGHT. REFER TO "A.W.S." FOR CABINET NUMBER LOCATED BELOW DIMENSION LINE.


## CONSTRUCTION KEYNOTES

- CONCRETE ENTRY SLAB (REFER TO STRUCTURAL)
- PLUMBING FIXTURE (REFER TO MECHANICAL)
- CASEWORK (REFER TO ELEVATIONS AND DETAILS)
- STAINLESS STEEL GRAB BARS
- PAPER TOWEL DISPENSER
- TOILET PAPER DISPENSER
- SANITARY NAPKIN RECEPTICLE
- MIRROR 18" x 36"
- SOAP DISPENSER
- RECESSED FIRE EXTINGUISHER CABINET
- FURNITURE AND EQUIPMENT (BY OWNER)
- SEMI-RECESSED DETENTION FIRE EXTINGUISHER CABINET
- PATCH AND REPAIR WALL CONSTRUCTION, WALL BASE, AND FLOORING TO MATCH EXISTING.
- COORDINATE LOCATION OF FLOOR TILE MOVEMENT JOINTS WITH ARCHITECT, TYPICAL OF TCNA EJ-171
- FIN TUBE RADIATOR (REFER TO MECHANICAL)
- PROVIDE NEW WATER COLD FLUID-APPLIED WATERPROOFING ALONG THE EXENT OF THE EXISTING FOUNDATION WALL - REFER TO CIVIL FOR COORDINATION OF NEW SIDEWALK, NEW ENTRY SLAB, AND FENCE MODIFICATIONS - USE CAUTION AS UNDERGROUND LINES ARE LOCATED IN THIS AREA.
- MECHANICAL CHASE VERIFY SIZE WITH KITCHEN EQUIPMETN MFR. AND MECHANICAL (REFER TO MECHANICAL)
- MECHANICAL CHASE VERIFY CLEAR WIDTH REQUIRED WITH MECHANICAL (REFER TO MECHANICAL)
- EYE WASH STATION (REFER TO FOOD SERVICE AND MECHANICAL)
- SEMI-RECESSED WET CHEMICAL FIRE EXTINGUISHER CABINET
- REFER TO MECHANICAL AND ELECTRICAL DRAWINGS.

1	BULLETIN NO 1	01/08/25
D.	REVISION	DATE

LE NO.  
91/20167.SDW

ENDING CODE 1C0DHHS7255	CONTRACT NO. Y22003
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OBJECT TITLE

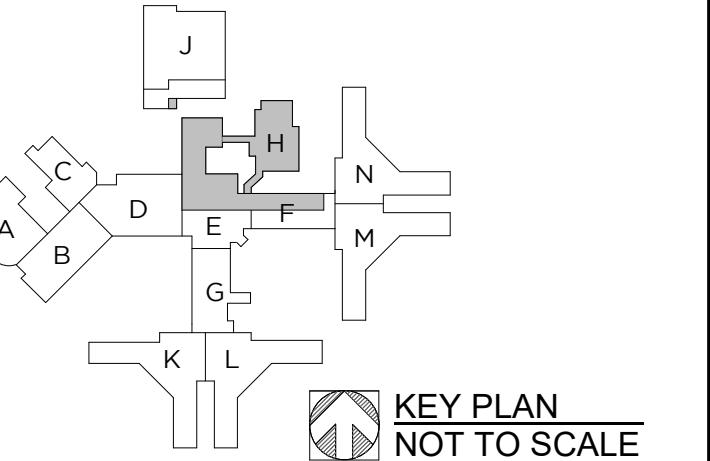491/20167.SDW - PHASE 500:


CENTER FOR FORENSIC  
PSYCHIATRY - CREATE  
KITCHEN

HEET TITLE  
**FIRST FLOOR  
CONSTRUCTION PLAN**


OBJECT NUMBER <b>2021094</b>	SHEET NUMBER <b>A2.21</b>
OBJECT DATE <b>SEPTEMBER 6, 2023</b>	
CHECKED BY <b>C.D.S.</b>	

ROOM FINISH SCHEDULE													
ROOM NO.	ROOM NAME	FLOOR	BASE	NORTH WALL	EAST WALL	SOUTH WALL	WEST WALL	CEILING	CLG. HEIGHT	REMARKS			
E124	GYMNASIUM	EXISTING	EXIST.	EXIST.	EXIST.	EXIST.	EXIST.	EXIST.	EXIST.	O			
E126	SECURE CORR.	EXIST. / R.W.B.	EXIST. / C.M.U.	PAINT	EXIST.	PAINT	EXIST. / C.M.U.	PAINT	EXIST.	O			
H104	WAREHOUSE	EXISTING	EXIST.	EXIST.	EXIST.	EXIST.	EXIST.	EXIST.	EXIST.	O			
H116A	SECUR. VEST.	C. TILE	C. TILE	C.M.U.	PAINT	C.M.U.	PAINT	C.M.U.	PAINT	SAT-1	9' - 0"		
H119	STORAGE	R.T.F.	R.W.B.	C.M.U.	PAINT	C.M.U.	PAINT	C.M.U.	PAINT	SAT-1	9' - 0"		
H120	CORRIDOR (WEST CONNECTOR)	SEALED CONC.	R.W.B.	C.M.U.	PAINT	—	C.M.U.	PAINT	C.M.U.	PAINT	SAT-1	9' - 0"	L
H121	STAIR	SEALED CONC.	R.W.B.	C.M.U.	PAINT	C.M.U.	PAINT	C.M.U.	PAINT	EXP.	PAINT		
H122	CORRIDOR	SEALED CONC.	R.W.B.	C.M.U.	PAINT	C.M.U.	PAINT	C.M.U.	PAINT	SAT-1	9' - 0"	L	
H123	KITCHEN	RSF	RSF COVE	C.M.U.	PAINT	C.M.U.	PAINT	C.M.U.	PAINT	SAT-2	9' - 0"	N	
H123A	DISH AREA	RSF	RSF COVE	C.M.U.	PAINT	C.M.U.	PAINT	C.M.U.	PAINT	SAT-2	9' - 0"	N	
H124	DRY STORAGE	RSF	RSF COVE	C.M.U.	PAINT	C.M.U.	PAINT	C.M.U.	PAINT	SAT-2	8' - 0"	N	
H125	OFFICE	RSF	RSF COVE	C.M.U.	PAINT	C.M.U.	PAINT	C.M.U.	PAINT	SAT-1	10' - 0"		
H126	STAFF TOILET	RSF	RSF COVE	C.M.U.	PAINT	C.M.U.	PAINT	C.M.U.	PAINT	SAT-1	8' - 0"		
H127	BREAK ROOM	RSF	RSF COVE	C.M.U.	PAINT	C.M.U.	PAINT	C.M.U.	PAINT	SAT-1	10' - 0"		
H128	CART WASH	RSF	RSF COVE	C.M.U.	PAINT	C.M.U.	PAINT	C.M.U.	PAINT	SAT-2	9' - 0"	N	
H129	CHEMICAL STOR.	RSF	RSF COVE	C.M.U.	PAINT	C.M.U.	PAINT	C.M.U.	PAINT	SAT-2	9' - 0"	N	
H130	SERVERY	RSF	RSF COVE	C.M.U.	PAINT	C.M.U.	PAINT	C.M.U.	PAINT	SAT-2	9' - 0"	N	
H131	SERVERY	C. TILE	C. TILE	C.M.U.	PAINT	C.M.U.	PAINT	C.M.U.	PAINT	SAT-1	9' - 0"		
H131C	DINING	C. TILE	C. TILE	C.M.U.	PAINT	C.M.U.	PAINT	C.M.U.	PAINT	SAT-1	9' - 0"		
H132	CORRIDOR (SOUTH CONNECTOR)	C. TILE	C. TILE	C.M.U.	PAINT	C.M.U.	PAINT	C.M.U.	PAINT	SAT-1	8' - 0"	L	
H133	CORR. (GYM CONN.)	R.T.F.	R.W.B.	C.M.U.	PAINT	C.M.U.	PAINT	C.M.U.	PAINT	SAT-1	9' - 0"		
H200	STAIR	SEALED CONC.	R.W.B.	C.M.U.	PAINT	C.M.U.	PAINT	C.M.U.	PAINT	EXP.	PAINT		
H201	MECHANICAL/ELECTRICAL	SEALED CONC.	—	GYP. BD.	PAINT	GYP. BD.	PAINT	GYP. BD.	PAINT	EXP.	PAINT		

DOOR & FRAME SCHEDULE														
DOOR NUMBER	ROOM NAME	DOOR PAIR	WIDTH	HEIGHT	THK.	MAT.	TYPE	FRAME	DETAILS	HEAD	JAMB	SILL	FLR. RATING	REMARKS
E124.C	GYMNASIUM	EXIST. (GYM CONN.)	3' - 0"	7' - 0"	1 3/4"	H.M.	D4	H.M.	F2	20'17.02 SIM.	11/A/31	30/A/02 SIM.	90	A, D, K, V
E126	SECURE CORR.	EXIST. / C.M.U.	3' - 0"	7' - 0"	1 3/4"	H.M.	D2	H.M.	F2	20/A/01	25/A/01	—	20	B, C, D, G, V
H120.A	CORR. (W. CONN.)	EXIST. / C.M.U.	3' - 6"	7' - 0"	1 3/4"	H.M.	D4	H.M.	F2	27/A/02	1/A/31	30/A/02	90	B, C, G, W
H120.B	CORR. (W. CONN.)	EXIST. / C.M.U.	10' - 0"	8' - 0"	1 3/8"	STEEL	D3	STEEL	-	27/A/01	28/A/01	—	H	
H120.C	CORR. (W. CONN.)	EXIST. / C.M.U.	3' - 0"	7' - 0"	1 3/8"	STEEL	D3	STEEL	-	27/A/01	28/A/01	—	H	
H120.D	CORR. (W. CONN.)	EXIST. / C.M.U.	3' - 0"	7' - 2"	1 3/4"	H.M.	D2	H.M.	F1	21/A/01	29/A/23	—	B	C, G, T
H120.E	CORRIDOR (WEST CONNECTOR)	EXIST. / C.M.U.	3' - 0"	7' - 2"	1 3/4"	H.M.	D2	H.M.	F1	21/A/01	29/A/23	—	C, G, T	
H121	STAIR	EXIST. / C.M.U.	3' - 0"	7' - 2"	1 3/4"	H.M.	D4	H.M.	F1	30/A/01	6/A/31	—	B	60 A, H, R, W
H122.A	SECUR. VEST.	EXIST. / C.M.U.	3' - 8"	7' - 2"	1 3/4"	WD	D2	H.M.	F1	20/A/01	6/A/31	—	20 B, C, G, S	
H122.B	CORRIDOR	EXIST. / C.M.U.	3' - 0"	7' - 2"	1 3/4"	WD	D2	H.M.	F1	20/A/01	6/A/31	—	B	30 C, G, R, Y
H122.C	CORRIDOR	EXIST. / C.M.U.	3' - 0"	7' - 2"	1 3/4"	WD	D2	H.M.	F1	20/A/01	6/A/31	—	B	30 C, G, R, Y
H122.D	CORRIDOR	EXIST. / C.M.U.	4' - 0"	7' - 2"	1 3/4"	WD	D2	H.M.	F1	21/A/01	29/A/23	—	C, D, G, T	
H122.E	DRY STORAGE	EXIST. / C.M.U.	3' - 0"	7' - 2"	1 3/4"	WD	D2	H.M.	F1	20/A/01	6/A/31	—	45 A, H	
H125.A	OFFICE	EXIST. / C.M.U.	3' - 0"	7' - 2"	1 3/4"	WD	D2	H.M.	F1	20/A/01	6/A/31	—	H, R	
H125.B	STAFF SCHED.	EXIST. / C.M.U.	3' - 0"	7' - 2"	1 3/4"	WD	D2	H.M.	F1	20/A/01	6/A/31	—	B	60 A, H, R, W
H125.C	STAFF SCHED.	EXIST. / C.M.U.	3' - 0"	7' - 2"	1 3/4"	WD	D2	H.M.	F1	20/A/01	6/A/31	—	B	60 A, H, R, W
H125.D	STAFF SCHED.	EXIST. / C.M.U.	3' - 0"	7' - 2"	1 3/4"	WD	D2	H.M.	F1	20/A/01	6/A/31	—	B	60 A, H, R, W
H125.E	STAFF SCHED.	EXIST. / C.M.U.	3' - 0"	7' - 2"	1 3/4"	WD	D2	H.M.	F1	20/A/01	6/A/31	—	B	60 A, H, R, W
H126	STAFF TOILET	EXIST. / C.M.U.	3' - 0"	7' - 2"	1 3/4"	WD	D2	H.M.	F1	20/A/01	6/A/31	—	H, R	
H127.A	BREAK ROOM	EXIST. / C.M.U.	3' - 0"	7' - 2"	1 3/4"	WD	D2	H.M.	F1	20/A/01	6/A/31	—	H, R	
H129.A	CHEMICAL STOR.	EXIST. / C.M.U.	3' - 0"	7' - 2"	1 3/4"	WD	D1	H.M.	F1	20/A/01	6/A/31	—	H	
H130.A	SERVERY	EXIST. / C.M.U.	3' - 0"	7' - 2"	1 3/4"	WD	D1	H.M.	F1	20/A/01	6/A/31	—	C, G	
H130.B	SERVERY	EXIST. / C.M.U.	3' - 0"	7' - 2"	1 3/4"	WD	D2	H.M.	F1	20/A/01	6/A/31	—	H, S, Y	
H130.C	SERVERY	EXIST. / C.M.U.	3' - 0"	7' - 2"	1 3/4"	WD	D2	H.M.	F1	20/A/01	6/A/31	—	H, S, Y	
H131.A	FINNING COOP. (S. CONN.)	EXIST. / C.M.U.	3' - 0"	7' - 2"	1 3/4"	WD	D2	H.M.	F1	20/A/01	6/A/31	—	B, H, S	
H131.B	SECUR. VEST.	EXIST. / C.M.U.	3' - 0"	7' - 2"	1 3/4"	WD	D2	H.M.	F1	20/A/01	6/A/31	—	B	G, J, P, Q, S
H131.C	DINING	EXIST. / C.M.U.	3' - 0"	7' - 2"	1 3/4"	WD	D2	H.M.	F1	29/A/01	5/A/31	—	B	D, E, G, U
H131.D	STAFF SCHED.	EXIST. / C.M.U.	3' - 0"	7' - 2"	1 3/4"	STEEL	D3	STEEL	CLASSIC	26/A/01	26/A/31	—	B	60 A, H, R, W
H132.A	SECURE CORR.	EXIST. / C.M.U.	3' - 6"	7' - 0"	1 3/4"	H.M.	D4	H.M.	F2	27/A/02	13/A/31	30/A/02	90	B, H, V
H132.B	STORAGE	EXIST. / C.M.U.	3' - 8"	7' - 2"	1 3/4"	H.M.	D1	H.M.	F1	20/A/01	6/A/31	—	45 A, H	
H132.C	CORRIDOR (SOUTH CONNECTOR)	EXIST. / C.M.U.	3' - 0"	7' - 2"	1 3/4"	WD	D2	H.M.	F1	21/A/01	5/A/31	—	B	D, E, G, U
H133.A	STAIR	EXIST. / C.M.U.	3' - 0"	7' - 2"	1 3/4"	WD	D4	H.M.	F1	20/A/01	6/A/31	—	D, K, S	
H200.A	STAIR	SEALED CONC.	—	GYP. BD.	PAINT	GYP. BD.	PAINT							

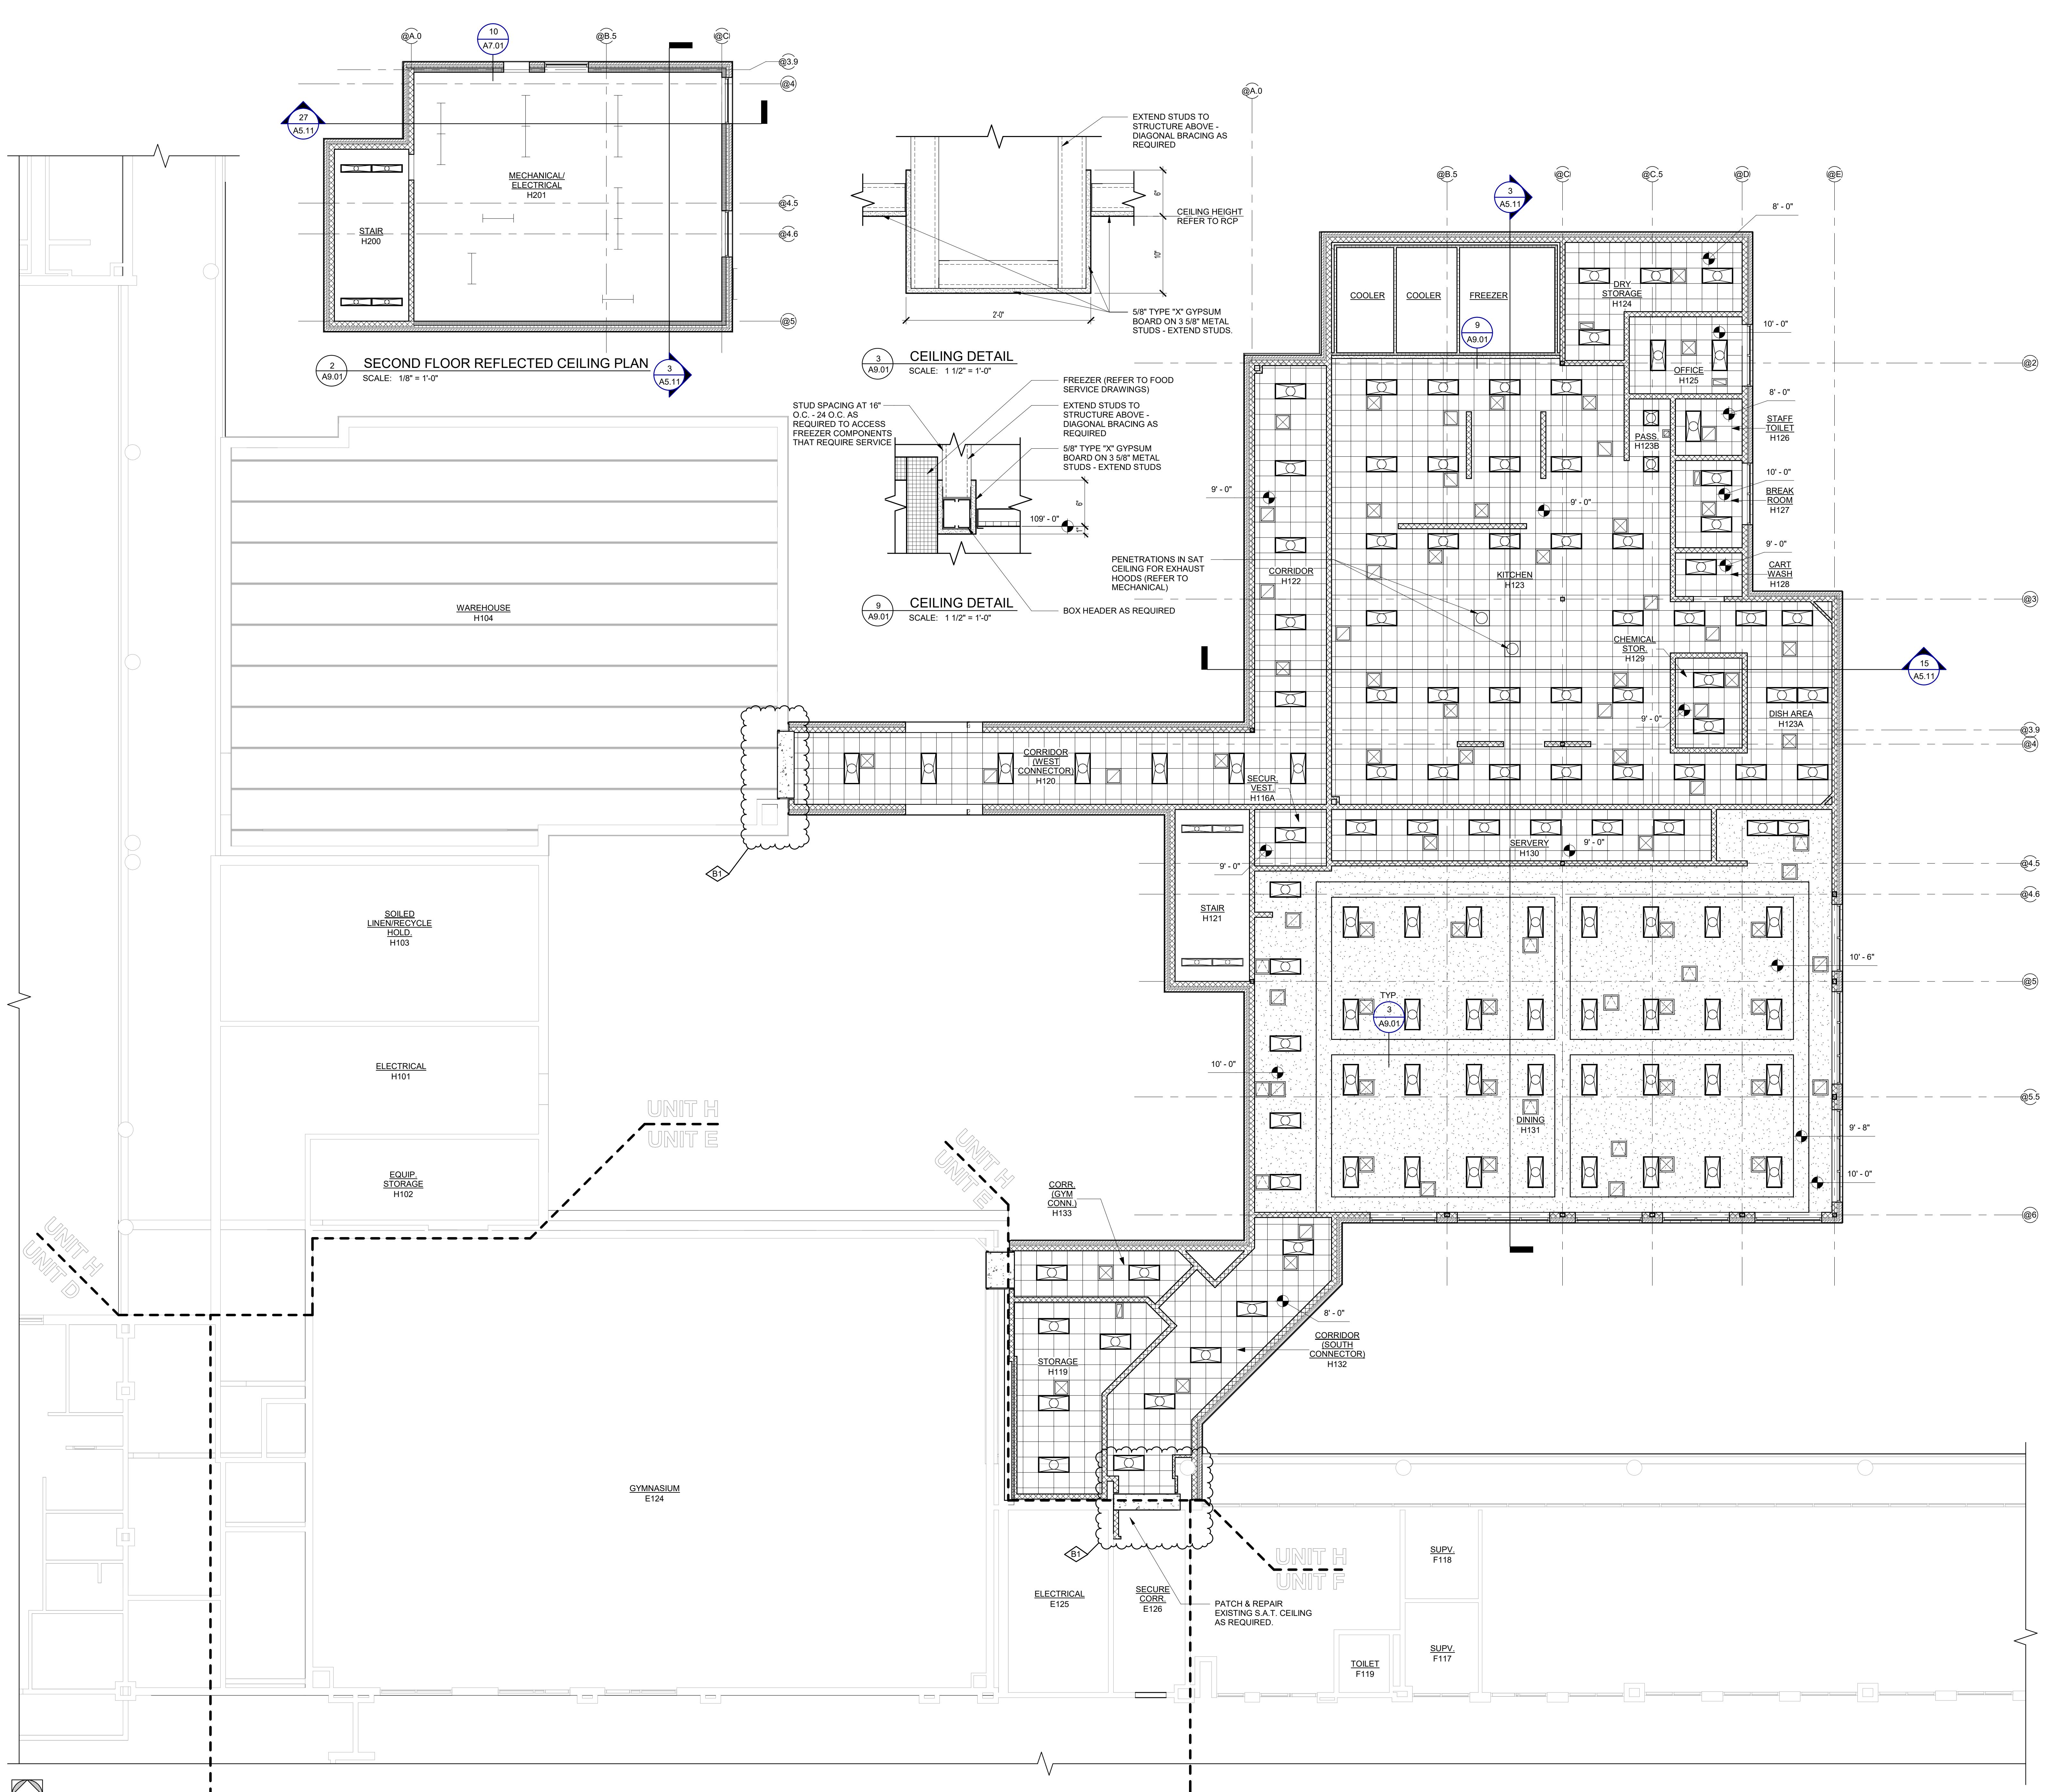

REFLECTED CEILING LEGEND:								
	LIGHT FIXTURES (REFER TO ELECTRICAL)							
	SUPPLY AIR GRILLE (REFER TO MECHANICAL)							
	RETURN AIR GRILLE / EXHAUST FAN (REFER TO MECHANICAL)							
	CEILING ACCESS PANEL - COORDINATE LOCATIONS WHERE CEILING ACCESS IS REQUIRED							
GENERAL CEILING NOTES:								
<ol style="list-style-type: none"> <li>1. COORDINATE INSTALLATION OF SUSPENDED CEILING SYSTEM WITH MECHANICAL AND ELECTRICAL SYSTEMS.</li> <li>2. POSITION LIGHT FIXTURES IN CENTER OF CEILING TILES UNLESS NOTED OR DIMENSIONED OTHERWISE.</li> <li>3. REFERENCE SPECIFICATIONS FOR SUSPENDED CEILING SYSTEM DESCRIPTION AND LOCATION REQUIREMENTS.</li> <li>4. ELECTRICAL FIXTURES ARE SHOWN FOR LOCATION REFERENCE ONLY, REFER TO ELECTRICAL DRAWINGS AND SPECIFICATIONS FOR DETAILS.</li> <li>5. FIRE DEVICES AND EXIT LIGHTING NOT INDICATED ON ARCHITECTURAL DRAWINGS. REFER TO ELECTRICAL DRAWINGS FOR LOCATION, DETAILS, AND SPECIFICATIONS.</li> <li>6. PROVIDE S.A.T. HOLD DOWN CLIPS AT EXTERIOR DOORS.</li> </ol>								
<p>STATE OF MICHIGAN DEPARTMENT OF TECHNOLOGY, MANAGEMENT AND BUDGET FACILITIES AND BUSINESS SERVICES ADMINISTRATION DESIGN AND CONSTRUCTION DIVISION ADAM LACH, RA, DIRECTOR</p>								
<p>FILE NO. 01/20167.SDW</p> <table border="1"> <tr> <td>RECORDING CODE 1C0DHHS7255</td> <td>CONTRACT NO. Y22003</td> </tr> </table> <p></p>			RECORDING CODE 1C0DHHS7255	CONTRACT NO. Y22003				
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<p>WTAARCH.COM</p> <p></p>								
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<p>PROJECT TITLE 01/20167.SDW - PHASE 500: CENTER FOR FORENSIC PSYCHIATRY - CREATE KITCHEN FLINT, MICHIGAN</p>								
<p>FLOOR TITLE FIRST &amp; SECOND FLOOR REFLECTED CEILING PLAN</p>								
<table border="1"> <tr> <td>OBJECT NUMBER 2021094</td> <td>SHEET NUMBER A9.01</td> </tr> <tr> <td>OBJECT DATE SEPTEMBER 6, 2023</td> <td></td> </tr> <tr> <td>CHECKED BY CDS</td> <td></td> </tr> </table>			OBJECT NUMBER 2021094	SHEET NUMBER A9.01	OBJECT DATE SEPTEMBER 6, 2023		CHECKED BY CDS	
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OBJECT DATE SEPTEMBER 6, 2023								
CHECKED BY CDS								

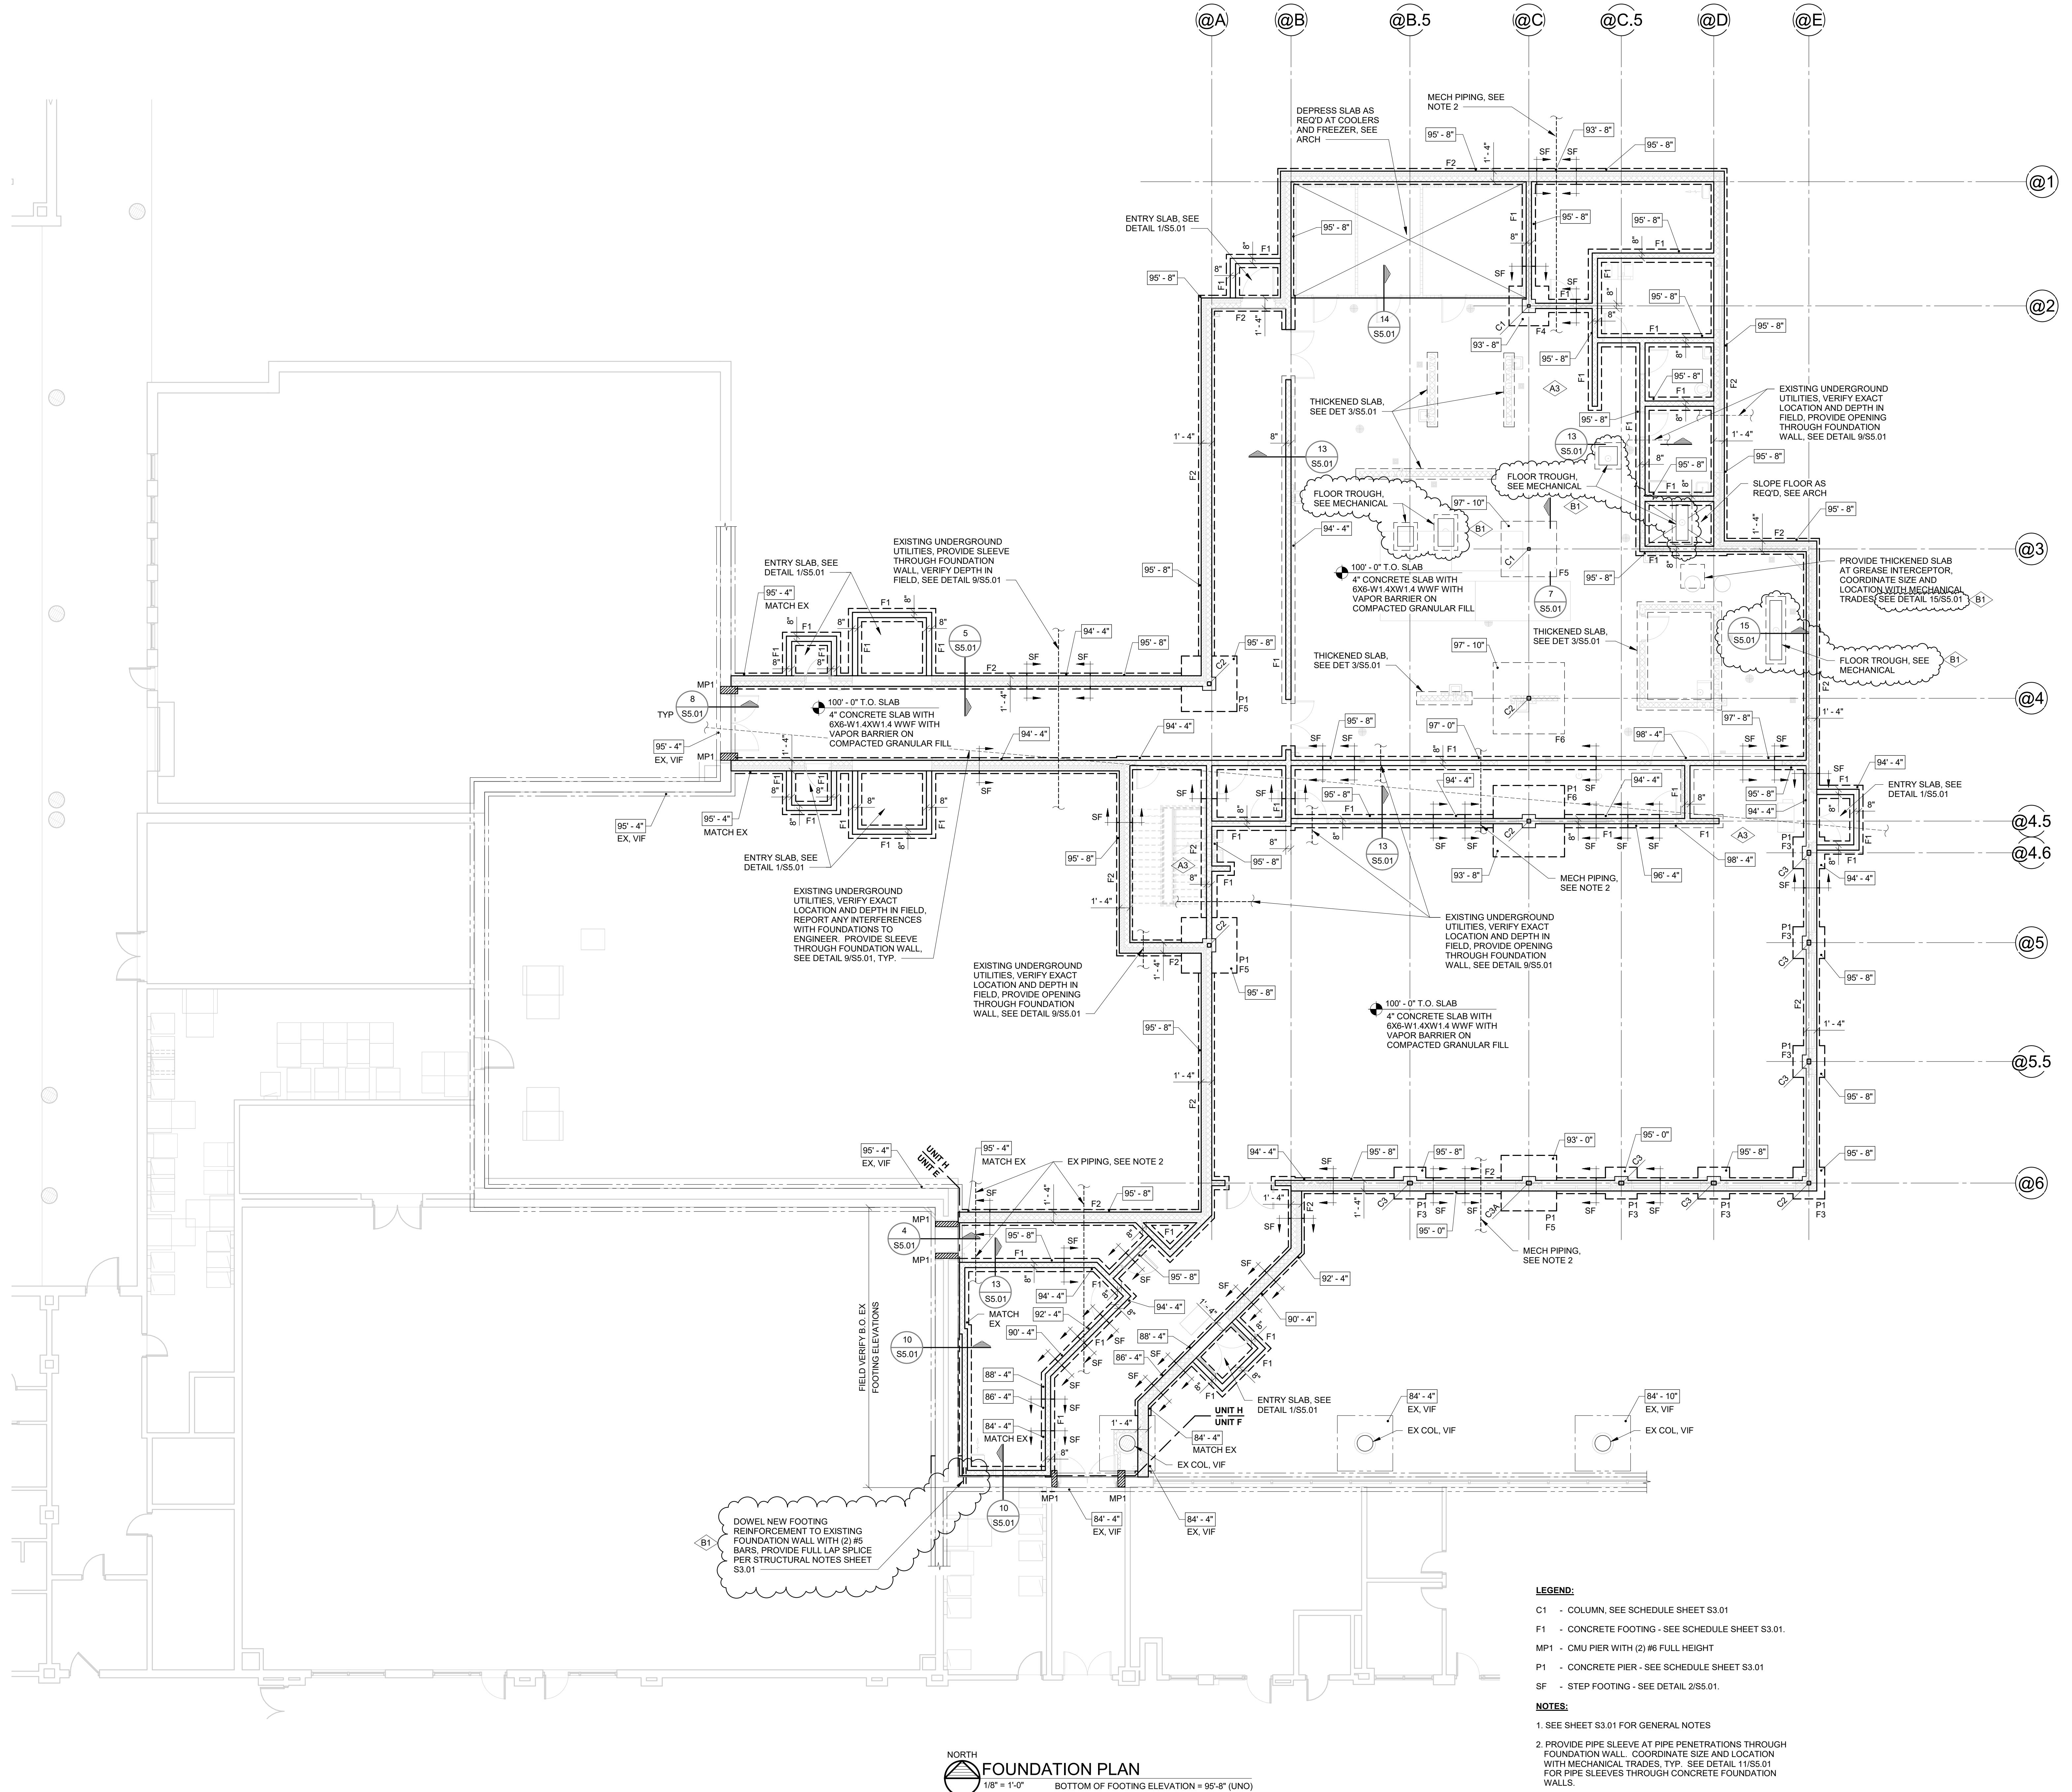


NORTH



# FOUNDATION PLAN

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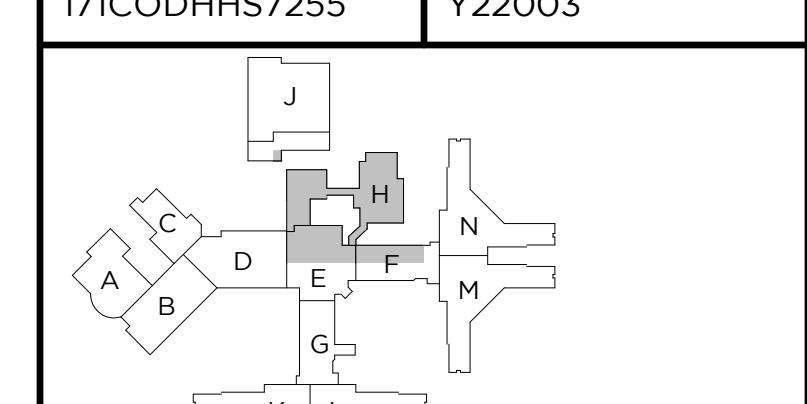
1/8" = 1'-0"      BOTTOM OF FOOTING ELEVATION = 95'-8" (UNO)

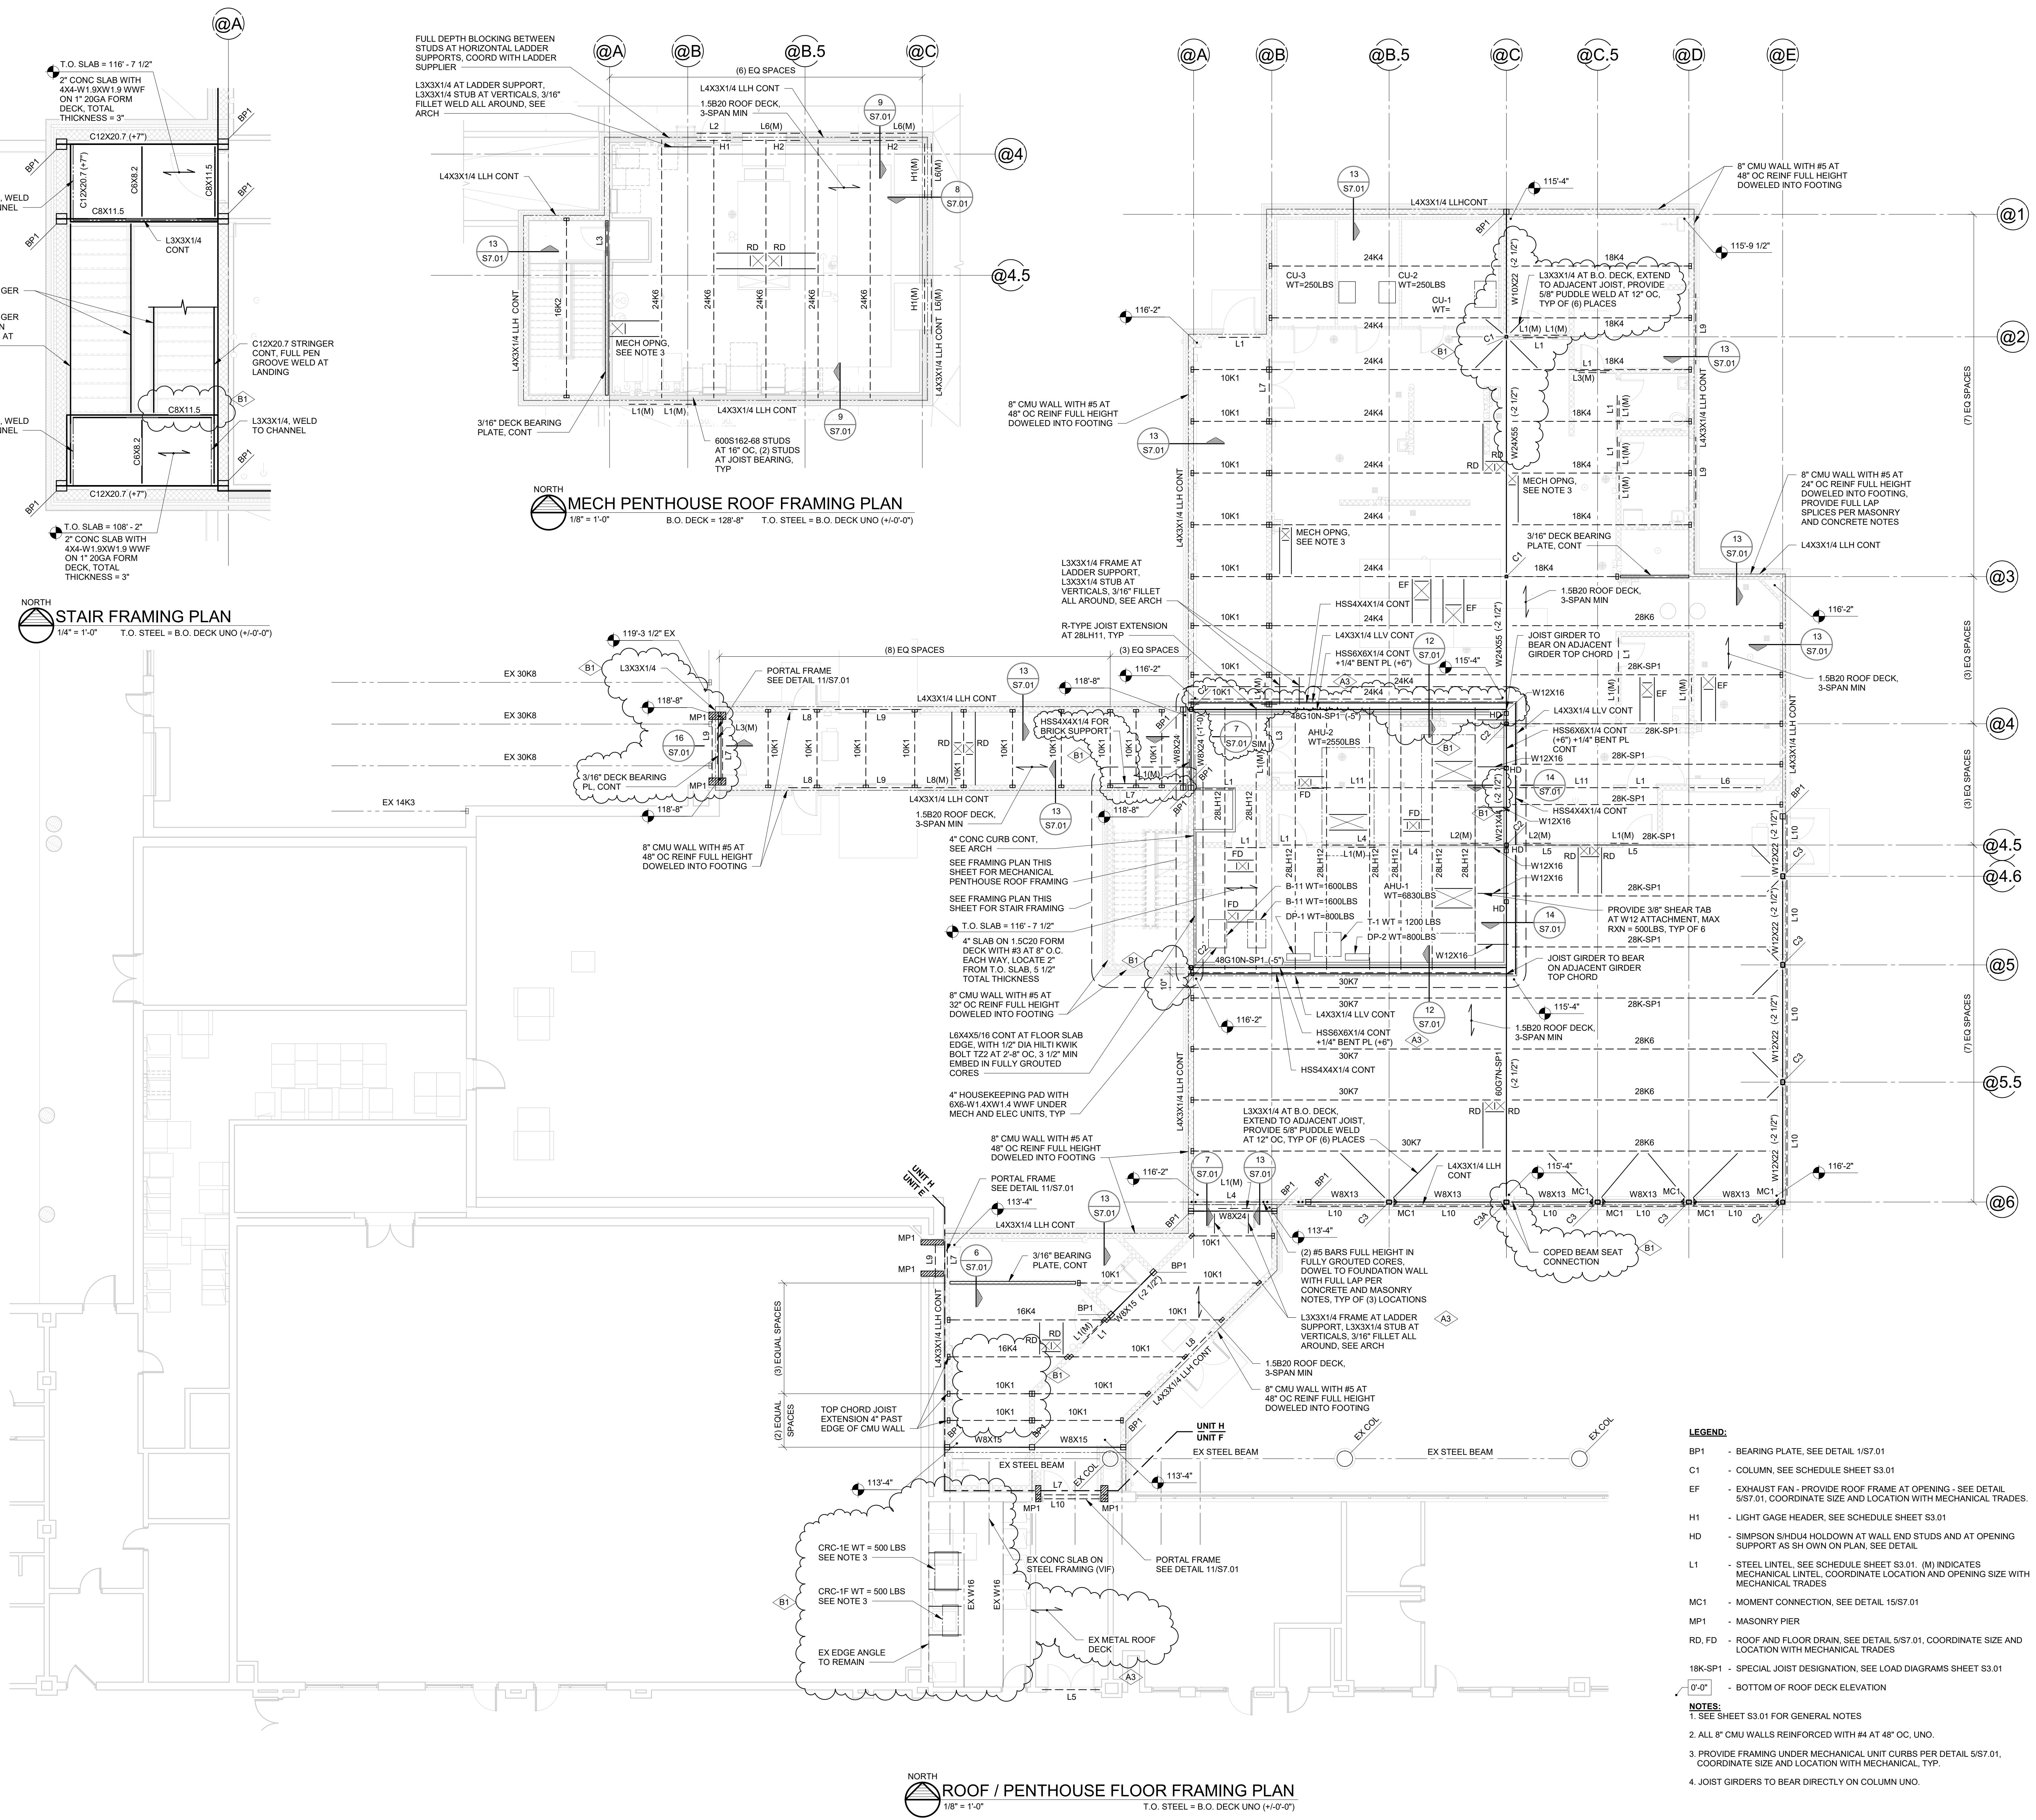

B1 BULLETIN NO. 1 01/08/25  
A3 ADDENDUM NO. 3 09/28/23  
NO. REVISION DATE  
STATE OF MICHIGAN  
DEPARTMENT OF TECHNOLOGY, MANAGEMENT AND BUDGET  
FACILITIES AND BUSINESS SERVICES ADMINISTRATION  
DESIGN AND CONSTRUCTION DIVISION  
ADAM LACH, RA, DIRECTOR

FILE NO. 491/20167.SDW

FUNDING CODE 171CODHS7255 CONTRACT NO. Y22003



KEY PLAN  
NOT TO SCALE

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(800) 894-4300 1 (800) 894-9390 WWW.MACMILLANASSOCIATES.COM

PROJECT TITLE

491/20167.SDW - PHASE 500:

**CENTER FOR FORENSIC  
PSYCHIATRY - CREATE  
KITCHEN**  
SALINE, MICHIGAN

SHEET TITLE

**ROOF FRAMING PLAN**

PROJECT NUMBER 2021094

PROJECT DATE SEPTEMBER 6, 2023


CHECKED BY JAG

**S2.02**







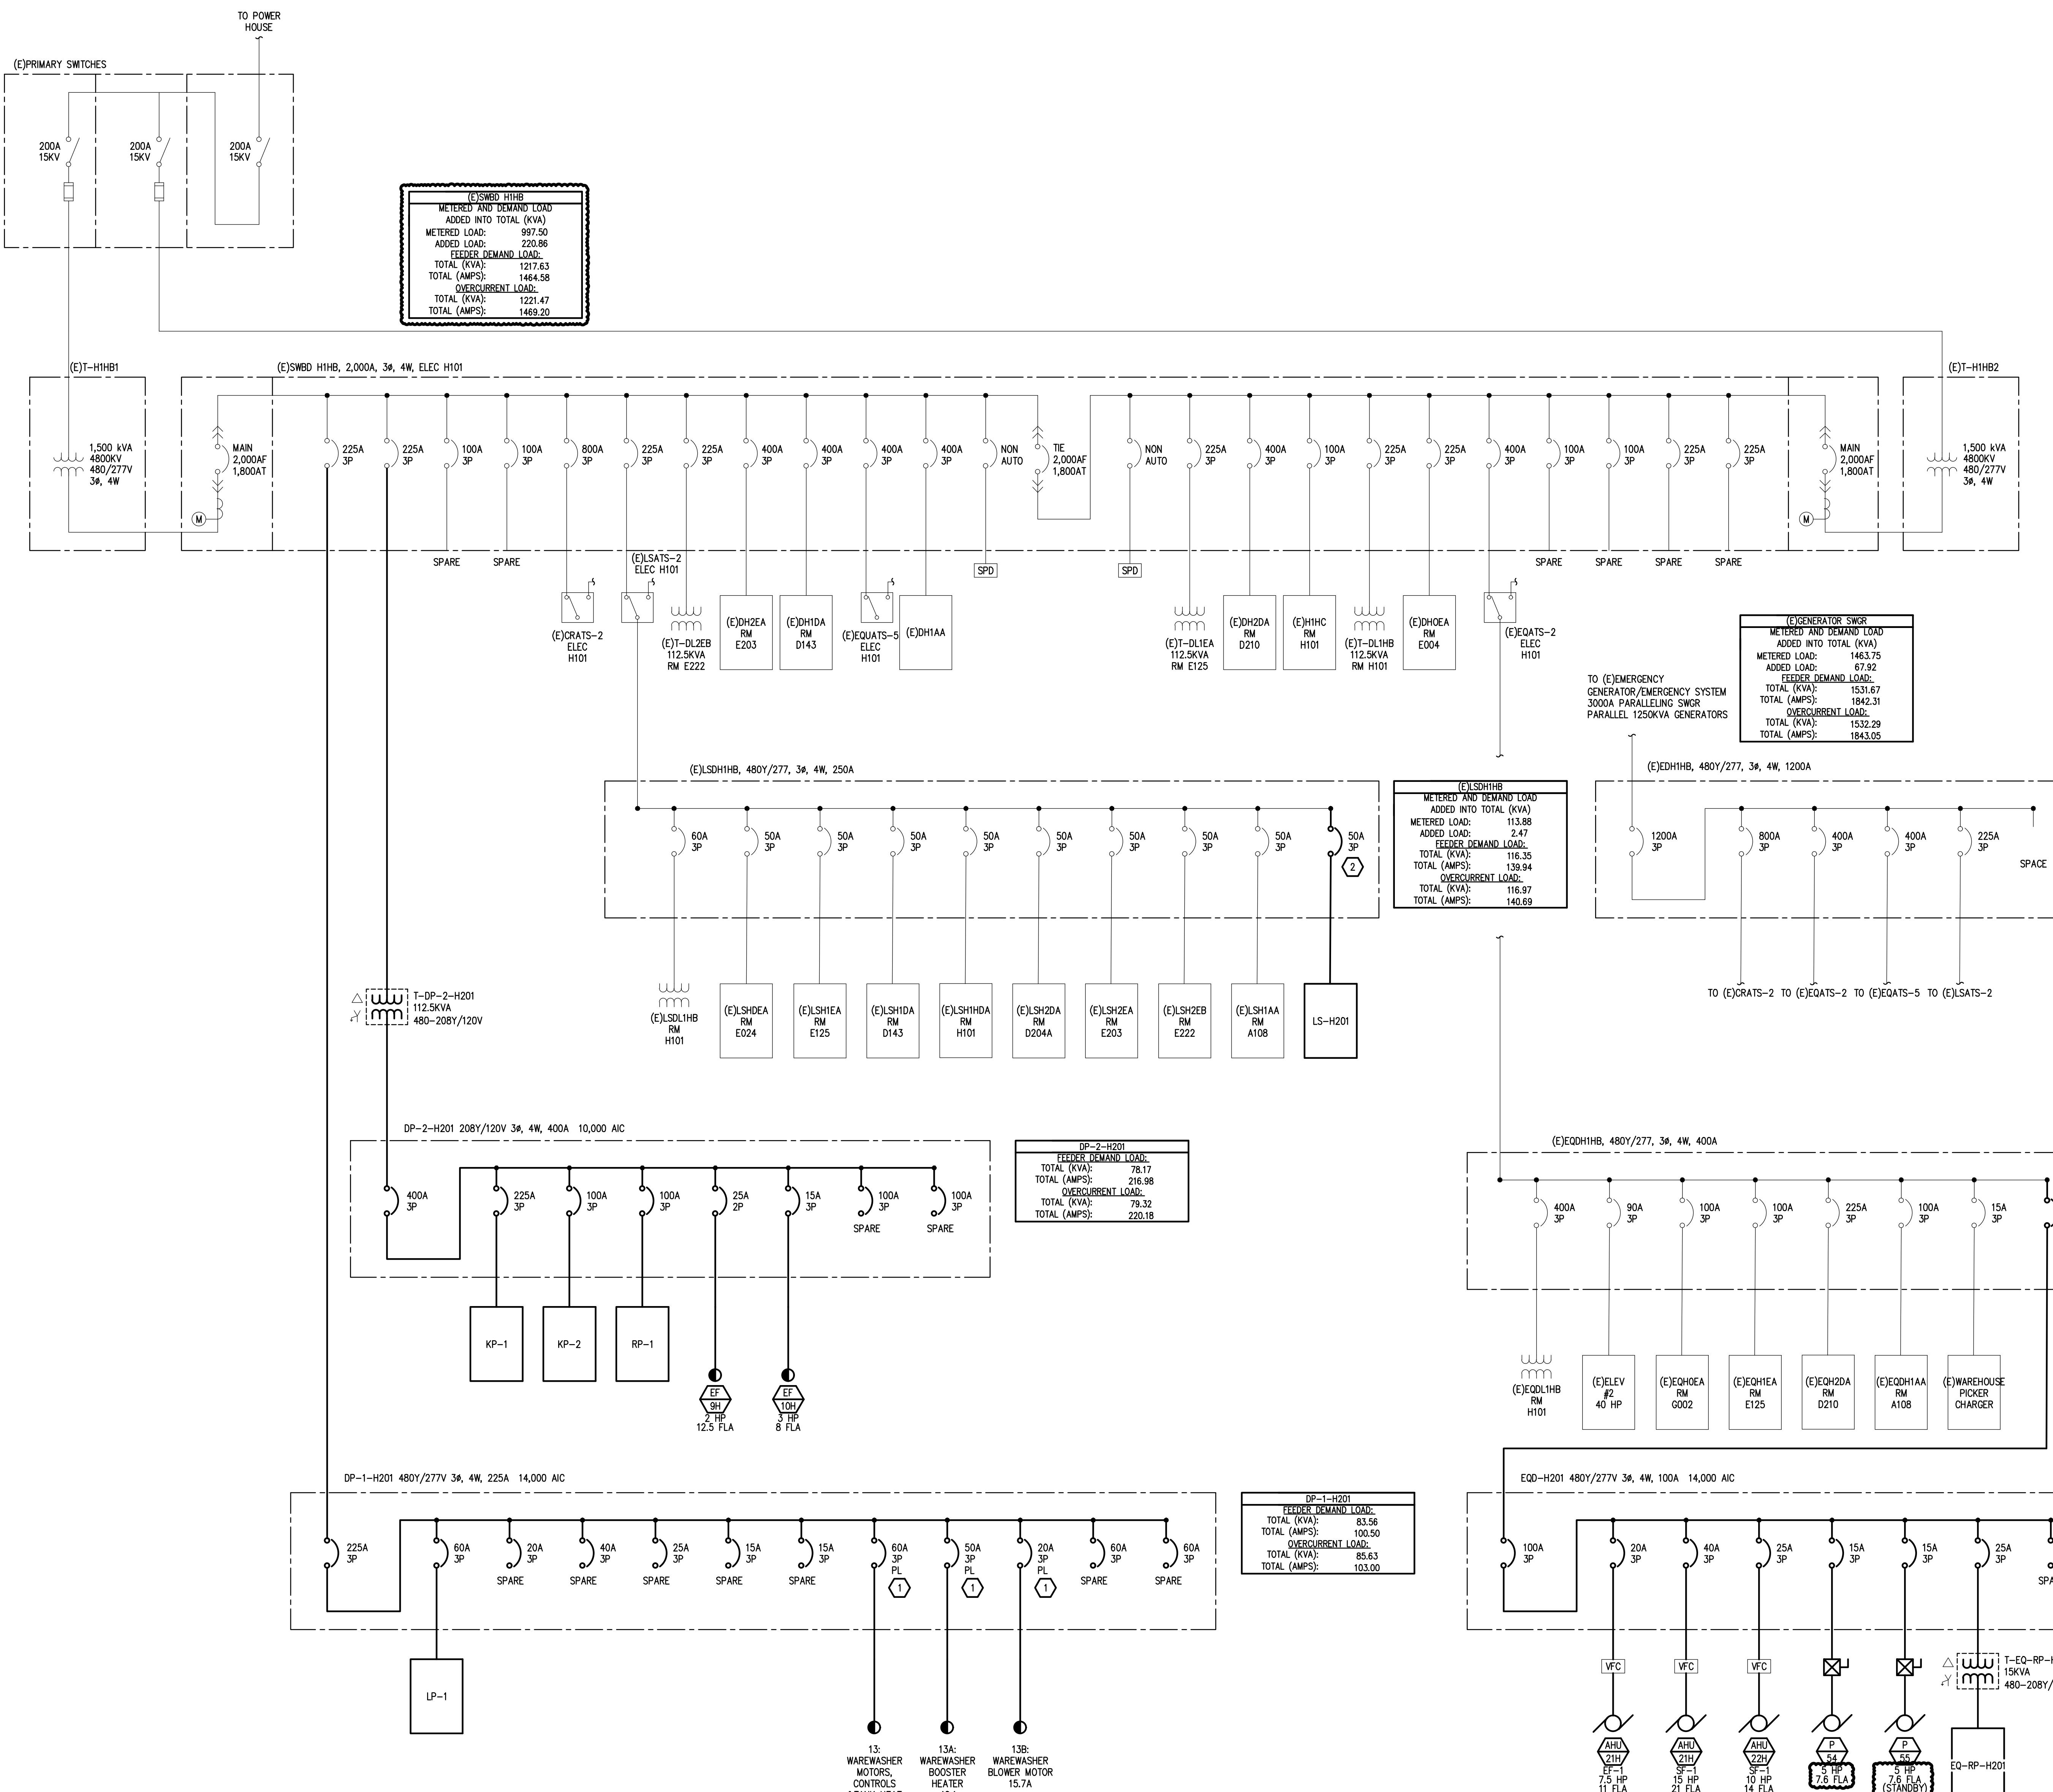

# ONE-LINE DIAGRAM - SWITCHBOARD H1HB

## DIAGRAM GENERAL NOTES:

- 1. THESE DRAWINGS REPRESENT THE GENERAL EXTENT AND ARRANGEMENT OF SYSTEMS. COORDINATE EXACT EQUIPMENT LOCATIONS, ELEVATIONS, AND FINAL CONNECTION REQUIREMENTS. PROVIDE EACH SYSTEM COMPLETE, INCLUDING ALL NECESSARY COMPONENTS, FITTINGS AND OFFSETS.
- 2. FEEDER AND BRANCH CIRCUIT CONDUCTORS SHALL BE SIZED IN ACCORDANCE WITH THE "FEEDER AND BRANCH CIRCUIT SIZING SCHEDULE—GENERAL PURPOSE" ON THE "ELECTRICAL STANDARD SCHEDULES DRAWING" UNLESS SPECIFICALLY NOTED OTHERWISE.
- 3. TRANSFORMER SECONDARY CONDUCTORS SHALL BE SIZED IN ACCORDANCE WITH THE "TRANSFORMER CIRCUIT SIZING SCHEDULE—GENERAL PURPOSE" ON THE "ELECTRICAL STANDARD SCHEDULES DRAWING" UNLESS SPECIFICALLY NOTED OTHERWISE.
- 4. MOTOR CIRCUIT PROTECTION SHALL BE SIZED IN ACCORDANCE WITH THE MOTOR CIRCUIT SIZING SCHEDULES ON THE "ELECTRICAL STANDARD SCHEDULES DRAWING" UNLESS SPECIFICALLY NOTED OTHERWISE.
- 5. BASIS OF DESIGN IS EATON/CUTLER-HAMMER POW-R-LINE DISTRIBUTION EQUIPMENT. IF THE CONTRACTOR ELECTS TO PROVIDE EQUIPMENT FROM OTHER APPROVED MANUFACTURERS, THE CONTRACTOR SHALL BE RESPONSIBLE TO COORDINATE THE LAYOUT AND CLEARANCE REQUIREMENTS IN ALL SPACES CONTAINING ELECTRICAL EQUIPMENT AND PROVIDE EQUIPMENT MEETING THE SPECIFICATIONS AND ACHIEVING CODE REQUIRED CLEARANCES WITHIN THE SPACE PROVIDED.
- 6. VARIABLE FREQUENCY CONTROLLERS (VFC) FURNISHED BY MECHANICAL TRADES. ELECTRICAL CONTRACTOR SHALL INSTALL VFC, PROVIDE POWER FEEDER FROM DISTRIBUTION EQUIPMENT TO VFC AND PROVIDE POWER FEEDER FROM VFC TO MOTOR. REFER TO SPECIFICATIONS FOR APPLICATION OF VFC POWER CABLE FROM VFC TO MOTOR.

## CONSTRUCTION KEY NOTES:

1. PROVIDE PADLOCKABLE HANDLE.
2. PROVIDE NEW CIRCUIT BREAKER IN EXISTING SPACE OF PANEL. EXISTING PANEL IS CUTLER-HAMMER POW-R-LINE PRL4 SERIES.

1	BULLETIN NO 1	01/08/25		
D.	REVISION	DATE		
 <p>STATE OF MICHIGAN  DEPARTMENT OF TECHNOLOGY, MANAGEMENT AND BUDGET  FACILITIES AND BUSINESS SERVICES ADMINISTRATION  DESIGN AND CONSTRUCTION DIVISION  ADAM LACH, RA, DIRECTOR</p>				
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<p>OBJECT TITLE  1/20167.SDW - PHASE 500:  <b>CENTER FOR FORENSIC  PSYCHIATRY - CREATE  KITCHEN</b>  ALINE, MICHIGAN</p>				
<p>HEET TITLE  <b>ONE LINE DIAGRAM - NEW  WORK</b></p>				
OBJECT NUMBER 2021094	SHEET NUMBER			
OBJECT DATE AUGUST 23, 2023	<b>E5.01</b>			
ECHECKED BY TLC				